ADDENDUM NO: 01

DATE: 13 August 2020

PROJECT NO: 143.004

PROJECT: T.O. Smith Elementary Rebuild

3295 Gramercy Ave

Ogden, Utah 84403

OWNER: Ogden School District

1950 Monroe Blvd. Ogden, Utah 84401



I II N D

NAYLOR

WENTWORTH

A R C H I T E C T S

THE ITEMS LISTED IN THIS **ADDENDUM** WILL BECOME PART OF THE GENERAL CONTRACT AND WILL BE INCLUDED IN THE APPROPRIATE DRAWING OR SPECIFICATION SECTION AS NOTED UNDER EACH OF THE FOLLOWING ITEMS.

GENERAL REQUIREMENTS

None

SPECIFICATIONS

Specification 00 0102 Index Vol I

1. Add specification 09 2513 Direct Applied EFS to the index, already included within the specification.

Specification 00 4100 Bid Form

1. Updated bid form attached with additional unit price.

Specification 00 7300 Supplementary General Conditions

Replace Supplementary General Conditions complete, revisions are highlighted in green.

Specification 01 1000 Summary

- 1. 1.04 Description of Demolition Work, Add Paragraphs B. and C. as follows:
 - B. The contractor shall salvage the following items and turn over to the owner:
 - 1. LED light Bulbs.
 - 2. Evaporation Coolers qty (4) (coordinate location with Owner / Construction Manager)
 - 3. Breakers in electric panels.
 - 4. 74 Gal water heater in boiler room.
 - C. The owner shall salvage the following items prior to demolition:
 - 1. Remove parts from boiler.
 - 2. Remove miscellaneous Kitchen equipment including walk-in cooler and freezer.

Specification 01 2200 Unit Prices

1. 1.07 Schedule of Unit Prices; add the following unit price:

ITEM	DESCRIPTION	UNIT	UNIT COST
7	Alternate flooring adhesive, refer to specification 09 0561	sq ft	

T.O. Smith Elementary Rebuild Ogden School District
Ogden, Utah Ogden, Utah

Specification 05 3400 Acoustical Metal Decking

- 1. 2.01 Manufacturers, B; revise item 4. As follows:
 - 4. New Millennium: www.newmill.com
 - a. Product: 3.5" Versa-Dek LS Acoustical

Note to contractors: This deck is 1" deeper than the basis of design and will require some minor modifications. Specifically, (but not limited to) the head details of the clerestory storefront types S12a, S12b, and S12c, which will be addressed if they are the successful bidder. This deck will also allow for more room to install the lateral sprinkler piping/heads.

Specification 07 2119 Foamed-In-Place Insulation

- 1. 2.01 Manufacturer, B; add the following Other Approved Manufacturer:
 - 8. SWD Urethane; Product: Quik-Shield 118

Specification 07 2500 Membrane Weather Barriers

- 1. 2.01 Air Infiltration Barrier, A, 7; add the following acceptable product:
 - c. Dorken Systems Inc.; Delta-Vent SA; www.dorken.com

Specification 07 7200 Roof Hatches and Accessories

- 1. 2.01 Roof Hatches, A; add the following acceptable manufacturer:
 - 8. Precision Ladders, LLC; www.precisionladders.com

Specification 08 7101 Hardware Sets

1. Replace this specification complete, revisions are highlighted in blue with deletions struck out in red.

Specification 09 0561 Common Work Results for Flooring Preparation

1. Replace this specification complete.

Specification 11 6133 Platform Rigging Systems and Curtains

- 1. 2.01 Manufacturers, A; add the following acceptable manufacturer:
 - 4. Janson Industries
 - a. Address: Canton, Ohio 44706
 - b. Phone: (303) 455-7029
 - c. Email: stage@iansonindustries.com

Specification 11 6623 Gymnasium Equipment

- 1. 2.04 Volleyball Equipment, A; add the following Manufacturer:
 - 5. Bison Inc; www.bisoninc.com
- 2. 2.05 Basketball Equipment, A; add the following Manufacturer:
 - 7. Bison Inc; www.bisoninc.com
- 3. 2.05 Basketball Equipment, C; add the following:
 - 7. Height Adjuster same as side court assemblies.

T.O. Smith Elementary Rebuild Ogden School District
Ogden, Utah Ogden, Utah

Specification 11 6643 Interior Electronic Scoreboards

- 1. 2.01 Manufacturers, C; add the following Other Manufacturer:
 - 6. Daktronics; www.daktronics.com

Specification 11 6813 Playground Equipment

- 1. 2.01 Playground Equipment, A, 2.; add the following Other Approved Manufacturer:
 - d. Playcraft Systems; www.playcraftsystems.com
- 2. 2.02 Basketball Equipment, A, 2.; add the following Other Approved Manufacturer:
 - f. Bison, Inc.; www.bisoninc.com

Specification 32 1840 Poured-in-Place Rubberized Surfacing

- 1. 2.01 Poured-In -Place Playground Surfacing System, A; add the following Manufacturers:
 - 4. DuraPlay, Inc.; www.duraplay.com
 - 5. Flexground; www.flexground.com

DRAWINGS

Sheet A105 - Area A2 Annotation Plan

1. 3A, Area A2 High Window Plan, add storefront window callouts S12a, S12b, S12c.

Sheet A407 – Interior Elevations

1. Elevation 1A, 5E, and 3E – Replaced 'Form Ply' verbiage with 'Form Liner' and identified the form liner. Replace sheet with attached.

Sheet A601 - Door Schedule

2. Door Schedule, Door B107a and B206a, revise hardware set from 39 to 39.1.

Sheet A610 - Opening Details

1. Detail 6E, 5E, and 4E – revised dimensions. Replace with attached sheet.

ATTACHED ADDENDA

- **Item 1.** Structural, (1) narrative sheet, and (3) 30" x 42" drawings.
- Item 2. Mechanical, (3) narrative sheets
- Item 3. Electrical, (3) narrative sheets and (10) 30" x 42" drawings.

END OF ADDENDUM

T.O.Smith Elementary Rebuild Ogden, Utah

Ogden School District Ogden, Utah

SECTION 00 4100 BID FORM

BID FOR: T.O. Smith Elementary School Rebuild

3295 Gramercy Ave Ogden, Utah 84403

TO: Ogden City School District

To Whom it may concern:

Purchasing Office, 1950 Monroe Blvd

Ogden, UT, 84401

Name of Bidder:	
Address:	
Phone #:	Fax#:
Contractor's Contact:	Phone #:
Contractors, License No.:	License Expiration Date:

The undersigned has carefully examined the site, the proposed Contract Documents consisting of Drawings, Specifications, and all Addenda prepared by NWL ARCHITECTS pertinent to the construction of the above referenced Project and further, being familiar with all other conditions affecting the Work, the undersigned hereby proposes and agrees to furnish and provide all labor, materials, supervision, transportation, tools, equipment, services and other facilities necessary and required for the expeditious completion of the Work included in the Bid Division indicated above, in strict conformity with said conditions and Contract Documents.

The undersigned has reviewed the work outlined in the Bid Division, fully understands the scope of work required in this Proposal, acknowledges that the Proposal includes the work of all trades.

The undersigned agrees to complete the work required within the Bid Division, within the time indicated in Contract Documents subject to liquidated damages as specified in the Contract Documents

Enclosed is a Bid Security for five percent (5%) of the amount of the Base Bid, made payable to the order of Ogden City District, to be left in escrow with the Owner as a guarantee that the undersigned will enter into a Contract and will furnish specified insurance and bonds.

The undersigned has notified the Construction Manager of any discrepancies or omissions, or of any doubt about the meaning of any of the Contract Documents, and has contacted the Construction Manager before bid date to verify the issuing of any clarifying Addenda.

ADDE I/We a		following addenda (Include All Adde	enda Received)	c.
	No:	Date:	· · · · · · · · · · · · · · · · · · ·	_
	No:	Date:		_
	No:	Date:		_
	No:	Date:		_
	No:	Date:		_
	No:	Date:		_
Exem The u	ption Certificate, to be filed ndersigned proposes to pro	teed for this project are tax exempt a with each vendor. wide and construct the Work, in acc se of (including allowances):	-	
	unt shall be shown in both v govern).	vords and figures. In case of discre	ollars(\$epancy, the amo	ount shown in words
Unit Pequipouthe Wellington	ment, plant, transportation, ork; overhead and profit. T	orm shall include full compensation services and incidentals; erection, a he following unit prices shall be use ecome necessary to change the qua	application or in ed to adjust the	stallation of an item of contract amount
As sp	ecified in 01 2200 provide the	ne following unit prices:		
A.	Removal and replacemen	nt of 100 sf of asphalt (RD-3/C102)	\$	/100 sq ft
B.	Removal and replacemen	nt of 100 sf of side walk (RD-5/C10	2) \$	/100 sq ft
C.	Removal and replacemen	nt of 10 lf of curb and gutter (RD-4/0	C102): \$	/10 lf
D. E.		nt of 10 If of waterway (H/C100): nain link type 1 fabric fencing	\$	/10 If
	with 2 installed posts 10 l	f:	\$	/10 If
F.	Additional (1) 4ft wide 6ft hig fabric swing gate:	nigh specified chain link type 1	\$	/Each
G.	Alternate flooring adhesiv	ve, refer to specification 09 0561	\$	/ sq ft

ALTERNATES

Prices included on the Bid Form shall include full compensation for all required labor, products, tools, equipment, plant, transportation, services and incidentals; erection, application or installation of an item of Work, including overhead and profit.

As specified in section 01 2300 pr	ovide cost for the following	g alternates:
Alternate No. 01: Sunpower Helix	– Photovoltaic System Eq	uipment.
Total Alternate Price		Dollars (\$
Alternate No. 02: Creative Energie	es – Photovoltaic System I	Equipment.
Total Alternate Price		Dollars (\$
Alternate No. 03: Ceramic Frit Pat	terned Glass specified in (08 8000 glass.
Total Alternate Price		Dollars (\$
ALLOWANCES As specified in section 01 2100 th	e following allowances sha	all be included in the base bid amount:
A. Cash allowance of \$25,000 for	residential appliances.	
B. Unit allowance to furnish and inconstruction. 1. Refer to section 08 3100 A	, ,	doors, location to be determined during
Unit price \$	each.	
Total allowance price		Dollars (\$

C. Owner Contingency Allowance: Include the stipulated sum/price of \$750,000.00 for use upon Owner's instructions.

AGREEMENT

It is understood and agreed that if written notice of the Owner's acceptance of this proposal is mailed, emailed, or delivered to the undersigned after the opening of the bid, and within Ninety (90) days, or at any time thereafter before this bid is withdrawn, the undersigned will execute and deliver to the Owner a Contract in accordance with the bid as accepted, and will also furnish and deliver to the Owner the Payment Bond, Performance Bond and Certificate of Insurance as specified, all within ten (10) working days after receipt of notification of award, and that the work under the Contract shall be commenced by the undersigned bidder, if awarded the Contract, on the date to be stated in a Notice to Proceed, issued to the Contractor and shall be completed by the Contractor in the time specified in the Contract Documents. In the event the bidder to whom an award is made fails or refuses to execute the Contract within the specified time frame, the Owner may declare the bidder's bid security forfeited as damages caused by the failure of the bidder to enter into the Contract.

Enclosed herewith is a listing of subcontractors, or scope of work being self-performed. If notified by the Construction Manager, Bidder must provide a binding certified copy of this list within twenty-four (24) hours of the notification. Failure to include this list in the bid or provide the certified list as described in the bidding instructions may result in a rejection of Bid.

The undersigned acknowledges the fact that the Owner reserves the right to accept or reject any and all proposals, to waive any informality in receipt of this proposal, with or without cause or reason, and award the Contract on the basis stated in the Instructions to Bidders.

NOTE: If bidder is a corporation, the legal name of the corporation shall be set forth below, together with the signatures of authorized officers or agents; if bidder is a partnership, the true name of the firm shall be set forth below together with the signature of the partner or partners authorized to sign contracts on behalf of the partnership; and if bidder is an individual, his signature shall be placed below.

Basis of Award: Contract award shall be based upon the sum of the Base Bid, Allowances, and District accepted alternates.

LIST OF SUBCONTRACTORS

PROJECT: T.O. Smith Elementary School Rebuild

Pursuant to the provisions as set forth in Instructions to Bidders, and the General Conditions, the above named Contractor hereby designates below the names and locations of the place of business of each subcontractor. District may request subcontractor license number

SUBCONTRACTOR (IF SELF PERFORM LIST)	BUSINESS ADDRESS	SCOPE OF WORK /(AMOUNTIF SELF PERFORM)

Ogden, Utah	Ogden School Distriction Ogden, Uta
Name of Bidder	
Authorized Signature	

END OF DOCUMENT

SECTION 00 7300

SUPPLEMENTARY GENERAL CONDITIONS

THE FOLLOWING SUPPLEMENTS MODIFY THE GENERAL CONDITIONS OF THE CONTRACT FOR CONSTRUCTION, AIA DOCUMENT A232, 2007 EDITION. WHERE A PORTION OF THE GENERAL CONDITIONS IS MODIFIED OR DELETED BY THESE SUPPLEMENTARY CONDITIONS, THE REMAINING UNALTERED PORTIONS OF THE GENERAL CONDITIONS SHALL REMAIN IN AS IS.

ARTICLE 1 GENERAL PROVISIONS

1.1 Basic Definitions

Add to Subparagraph 1.1.4 - The Project as follows:

1.1.4 The project is more completely defined under Section 01 1000, Summary of the Work

1.2 Correlation and Intent of the Contract Documents

Add to Subparagraph 1.2.1 as follows:

- 1.2.1 In the event of conflicts or discrepancies among the Contract Documents, interpretations will be based on the following priorities:
- The Agreement.
- 2) Addenda, with those of later date having precedence over those of earlier date.
- 3) The Supplementary Conditions.
- 4) The General Conditions of the Contract for Construction. Drawings and Specifications.

In the case of an inconsistency between Drawings and Specifications or within either Document not clarified by addendum, the better quality or greater quantity of work shall be provided in accordance with the Architect's interpretation.

The Contractor shall not 'scale' the Contract Document drawings to define dimensions or locations of building walls, columns, etc. Review dimensioned drawings to define required locations, if not indicated, coordinate and review with the Architect prior to continuing construction.

ADD NEW SUBPARAGRAPH 1.2.4 AS FOLLOWS:

1.2.4 The omission of minor details of construction, installation, material or other essential items of usual or standard construction from the drawings or specifications shall not relieve the Contractor from furnishing the same in place complete. Such omission shall not entitle this Contractor to make claims for extras on material or labor.

ARTICLE 2 OWNER

2.3 Information and Services Required of the Owner

Delete Subparagraph 2.3.5. and substitute the following:

2.3.5 The Architect will furnish to the General Contractor a complete set of electronic format construction documents (drawings and specifications) for the project. It will then be the General Contractors responsibility to distribute said documents, either electronic or hard copy to his Subcontractors that will be necessary for the execution of the work.

ARTICLE 3 CONTRACTOR

3.6 **Taxes**

Delete Subparagraph 3.6.1 and substitute the following:

3.6.1 Beginning January 1, 1996, the State of Utah provided an exemption from sales tax for construction materials purchased for public education. The exemption applies to all construction materials purchased by or on behalf of institutions of the public education system, provided the construction materials are clearly identified and installed or converted to real property which is owned by the public education institution. It is the intent of the Ogden School District to take advantage of the tax exemption on all construction material used in the TO Smith Elementary Rebuild . The Owner can take advantage of this exemption by structuring its agreements with its Contractor and suppliers so that title to construction material passes from the supplier to the Owner or the Contractor (on behalf of the Owner) upon delivery to the construction site after January 1, 1996. Tax exempt form TC-721 must be used by the vendors when purchasing construction materials. The Owner will provide a Form TC-721, signed by the Ogden School District Director of Purchasing, or designee, authorizing the exemption of sales tax on material purchases for the Contractor's use in purchasing materials. Refer to State Tax Commission, Publication 35, Rev. 6/96 or Tax Bulletin 16-96.

3.7 Permits, Fees, Notices and Compliance with Laws

Delete Subparagraph 3.7.1 and substitute the following:

3.7.1 The Contractor shall secure and the Owner shall pay for any permits, fees and inspections required by work included in this Contract. All licensing shall be secured and paid for by the Contractor.

Modify Subparagraph 3.7.4 as follows:

3.7.4 Three (3) days in lieu of fourteen (14) days.

Modify Subparagraph 3.7.5 as follows:

3.7.5 Amend the first sentence in this subparagraph to read, "If, in the course of the Work, the Contractor encounters human remains or recognizes the existence of burial markers, wetlands or hazardous waste deposits not indicated in the Contract Documents, the Contractor shall immediately suspend any operations that would affect them and shall notify the Owner and Architect."

3.8 Allowances

Modify Subparagraph 3.8.2.1 as follows:

.1 Allowances shall cover the total cost to the Contractor of materials and equipment delivered to the site, labor, installation costs, overhead and profit, other expenses contemplated, and all required taxes (if any) less applicable trade discounts.

Omit Subparagraph 3.8.2.2.

No changes to Subparagraph 3.8.2.3.

Add Subparagraph 3.8.2.4 as follows:

.4 At closeout of contract, funds remaining in Contingency Allowance will be credited to the Owner by Change Order.

3.10 Contractor's Construction and Submittal Schedules

Modify Subparagraph 3.10.1 as follows:

3.10.1 In the first sentence change the word "promptly" to "within seven days of Owner/Architect acceptance of Subcontractor List".

Add new Subparagraph 3.10.1.1 as follows:

.1 The Contractor shall show this information in the form of either C.P.M. or bar graph.

Modify Subparagraph 3.10.2 as follows:

- 3.10.2 In the first sentence change the word "promptly" to "within seven (7) days of Owner/Architect acceptance of Subcontractor List".
- 3.10.2 Substitute the words, "Architect's Review," for "Architect's Approval," in this paragraph.

3.11 Documents and Samples at the Site

Add new Subparagraph 3.11.1 as follows:

3.11.1 The Contractor shall also be responsible for providing a work table and dedicated set of documents with addenda, change orders, etc. for use only by the special inspector.

3.12 Shop Drawings, Product Data and Samples

Modify Subparagraph 3.12.8 as follows:

3.12.8 Substitute the words, "Review," for "Approval," in this paragraph.

ARTICLE 4 ARCHITECT AND CONSTRUCTION MANAGER

4.2_Administration of the Contract

Modify Subparagraph 4.2.11 as follows:

- 4.2.11 Omit the words, "and approve" and add "and review" in the first sentence in this subparagraph.
- 4.2.11 Amend the last sentence in this subparagraph to read, "The Architect's review of a specific item shall not indicate approval of the item or the assembly of which the item is a component."

ARTICLE 5 SUBCONTRACTORS

5.2 Award of Subcontracts and other Contracts for Portions of the Work

Modify Subparagraph 5.2.1 as follows:

b. 5.2.1 Omit the words, "as soon as practicable" and add "No later than twenty four (24) hours"

Modify Subparagraph 5.2.4 as follows:

5.2.4 The Contractor shall not change a Subcontractor, person or entity previously selected without written notification and acceptance of the Owner and Architect.

ARTICLE 6

CONSTRUCTION BY THE OWNER OR BY SEPARATE CONTRACTORS

No modifications.

ARTICLE 7 CHANGES IN THE WORK

Replace 7.2 Change Orders as follows

- 7.2.1 A Change Order is a written instrument prepared by the Construction Manager and signed by the Owner, Construction Manager, Architect, and Contractor, stating their agreement upon all of the following:
 - 1 The change in the Work;
 - 2 The amount of the adjustment, if any, in the Contract Sum; and
 - 3 The extent of the adjustment, if any, in the Contract Time.
- 7.2.2 Markup Percentage Fee:

- .1. Net amount of less than \$5,000. Percentage Fee to be paid to any Contractor (regardless of tier) on self performed work shall be a single markup percentage not to exceed 15% of the net amount.
- .2. Net amount of \$5,000 or greater. Percentage Fee to be paid to any Contractor (regardless of tier) on self performed work shall be a single markup percentage not to exceed 10% of the net amount.
- .3. The Markup Percentage Fee to be paid to any Contractor (regardless of tier) on any Subcontractor Work shall be a single percentage not to exceed 5% of the total allowable cost of sublet Work.

7.2.3 Change Order Proposals

.1 Change Order proposals require itemization. Details to be submitted will include a material and labor quantity take off and related pricing information and extensions from each subcontractor and material supplier.

ARTICLE 8 TIME

8.2 Progress and Completion

Add new Subparagraph 8.2.4 as follows:

8.2.4 Substantial completion of the Work shall be achieved as stipulated on Bid Form and in Owner/Contractor Agreement.

ARTICLE 9 PAYMENTS AND COMPLETION

9.3 Applications for Payment

Add the following sentence to Subparagraph 9.3.1:

9.3.1 The form of Application for Payment shall be notarized AIA Documents G732 Application and Certificate for Payment and G703 Continuation Sheet.

Add new Subparagraph 9.3.1.3 as follows:

9.3.1.3 Until the Work is one hundred percent (100%) complete, the Owner shall pay ninety-five percent (95%) of the amount due the Contractor on account of progress payments.

Add new Subparagraph 9.3.1.4 as follows:

9.3.1.4 The initial contract payment shall not be approved by the Construction Manager and Architect without a Contractor Master schedule having been prior approved by the Construction Manager. No subsequent monthly contract payment shall be approved by the Construction Manager or Architect without an approved updated contractor Master schedule.

9.6 Progress Payments

Modify Subparagraph 9.6.1 to read as follows:

9.6.1 Notice of extended payment provision. Application and certification for payment received by the fifth day of the month shall be reviewed and accepted or rejected by the tenth day of the month.

This Contract shall allow the Owner to make payment within thirty (30) days after acceptance of billings.

9.8 Substantial Completion

Add the following sentence to Subparagraph 9.8.5:

9.8.5 The payment shall be sufficient to increase the total payments to 100 percent of the Contract Sum, less such amounts the Architect and Construction Manager shall determine for incomplete Work and unsettled claims.

ADD NEW PARAGRAPH 9.11 AS FOLLOWS:

9.11 Liquidated Damages

9.11.1 The Contractor and the Contractor's surety shall be liable for and shall pay the Owner the sums hereinafter stipulated as **liquidated damages** for each calendar day of delay until the Work is complete: \$3000 for Substantial completion and \$1500 for Final completion.

9.11.2 Should the Contractor fail to complete the Work within the time agreed upon in the Contract Documents, or within such additional time as may have been allowed by extension, there shall be deducted from any moneys due or that may become due the Contractor the sum as stated in paragraph 9.11.1. Such sum is fixed and agreed upon by the Owner and Contractor as liquidated damages due the Owner by reason of inconvenience and added costs of administration, engineering, and supervision resulting from the Contractor's default, and not as a penalty.

9.11.3 Permitting the Contractor to continue and finish the Work or any part of the Work after the time fixed for its completion, or after the date to which the time for completion may have been extended, shall in no way operate as a waiver on the part of the Owner of any of his rights under the Agreement.

ARTICLE 10

PROTECTION OF PERSONS AND PROPERTY

No modifications.

ARTICLE 11 INSURANCE AND BONDS

INSURANCE AND BONDS

In addition to the insurance required under Article 11, the Contractor shall effect and maintain the following insurance:

ISR	CLUSIONS AND CONDITIONS OF SUCH		CIES. LIN	IITS SHOWN MAY HAVE BI	EN REDUCED BY	PAID CLAIMS		
TR	TYPE OF INSURANCE	INSD	WVD	POLICY NUMBER	(MM/DD/YYYY)	(MM/DD/YYYY)	LIMIT	s
A	X COMMERCIAL GENERAL LIABILITY CLAIMS-MADE X OCCUR	Υ	Y				EACH OCCURRENCE DAMAGE TO RENTED PREMISES (Ea occurrence)	\$ 1,000,000 \$ 300,000
	X X, C, U						MED EXP (Any one person)	\$ 5,000
	X Contractual Liab						PERSONAL & ADV INJURY	\$ 1,000,000
	GEN'L AGGREGATE LIMIT APPLIES PER:						GENERAL AGGREGATE	\$ 2,000,000
	X POLICY X PRO- JECT LOC						PRODUCTS - COMP/OP AGG	\$ 2,000,000
	OTHER:							S
C	AUTOMOBILE LIABILITY	Y	Y				COMBINED SINGLE LIMIT (Ea accident)	\$ 1,000,000
1	X ANY AUTO						BODILY INJURY (Per person)	S
	ALL OWNED SCHEDULED AUTOS						BODILY INJURY (Per accident)	s
- [X HIRED AUTOS X NON-OWNED AUTOS						PROPERTY DAMAGE (Per accident)	s
								\$ Coll. Ded \$1,000
3	X UMBRELLA LIAB X OCCUR	Y	Y				EACH OCCURRENCE	\$ 5,000,000
- [EXCESS LIAB CLAIMS-MADE						AGGREGATE	\$ 5,000,000
1	DED X RETENTION\$ 10,000							s
	WORKERS COMPENSATION AND EMPLOYERS' LIABILITY				Ĭ		PER OTH- STATUTE ER	
- 1	ANY PROPRIETOR/PARTNER/EXECUTIVE	N/A					E.L. EACH ACCIDENT	\$ 1,000,000
- 1	(Mandatory in NH)	N/A					E.L. DISEASE - EA EMPLOYEE	s 1,000,000
	If yes, describe under DESCRIPTION OF OPERATIONS below						E.L. DISEASE - POLICY LIMIT	s 1,000,000
-	Professional Liability						Per Occurrence Aggregate Limit Retension	\$1,000,000 \$1,000,000 \$50,000

The above policy shall name the Owner, Architect, and Construction Manager as additional insured. Reference is made to Paragraph 3.18, Indemnification, of AIA Document A232 Contractor shall furnish the Owner with certificates of insurance complying with all requirements. The certificates shall be signed by a person authorized to bind coverage on the insurer's behalf. Coverage on a claims-made basis will not be acceptable.

11.1 Contractor's Insurance and Bonds

Add the following paragraph:

11.1.1.1 The Contractor shall provide insurance coverage for portions of the Work stored off the site after written approval of the Owner at the value established in the approval, and also for portions of the Work in transit.

Add the following paragraphs:

11.1.2.1 The Contractor shall furnish bonds covering faithful performance of the Contract and payment obligations arising there under. Costs of bonds shall be included in the Contractor's bid. The amount of each bond shall be equal to one hundred percent (100%) of the Contract Sum.

11.1.2.2 The Contractor shall deliver the required bonds to the Owner not later than three days following the date the Agreement is entered into.

11.1.2.3 The Contractor shall require the attorney-in-fact who executes the required bonds on behalf of the surety to affix thereto a certified and current copy of the power of attorney.

ARTICLE 12

UNCOVERING AND CORRECTION OF WORK

No modifications.

ARTICLE 13 MISCELLANEOUS PROVISIONS

13.5 Tests and Inspections

Modify Subparagraph 13.5.1 as follows:

13.5.1 Substitute the words, "review or reviews," wherever the words, "approve, approval, or approvals," occur in this paragraph.

ADD NEW PARAGRAPH 13.8 AS FOLLOWS:

13.8 Equal Opportunity

13.8.1 The Contractor shall maintain policies of employment as follows:

- .1 The Contractor and the Contractor's Subcontractors shall not discriminate against any employee or applicant for employment because of race, religion, color, sex or national origin. The Contractor shall take affirmative action to ensure that applicants are employed, and that employees are treated during employment without regard to their race, religion, color, sex or national origin. Such action shall include, but not be limited to, the following: employment, upgrading, demotion or transfer; recruitment or recruitment advertising; layoff or termination; rates of pay or other forms of compensation; and selection for training, including apprenticeship. The Contractor agrees to post in conspicuous places, available to employees and applicants for employment, notices setting forth the policies of non-discrimination.
- .2 The Contractor and the Contractor's Subcontractors shall, in all solicitations or advertisements for employees placed by them or on their behalf, state that all qualified applicants will receive consideration for employment without regard to race, religion, color, sex or national origin.

ADD NEW PARAGRAPH 13.9 AS FOLLOWS:

13.9 Compliance with Labor Laws

13.9.1 The Contractor and the Contractor's Subcontractors shall comply with all applicable Laws and Regulations relating to labor on Public Works in the State of Utah, including *U.S. Code Title 8 USC Sec.1324a, Utah Code Title 34 Chapter 30 ant Title 13 Chapter 47*:

- 13.9.2 The following references are included herein so that the Contractor shall be aware of specific requirements of these sections. Other Law sections are not shown herein, but this in no way relieves the Contractor of His obligation to comply with all Federal, State, and Local Labor Laws.
- .1 *U.S. Code Title 8 USC Sec. 1324a Unlawful Employment* (1)(A) It is unlawful for a person or other entity to hire, or to recruit or refer for a fee, for employment in the United States an alien knowing the alien in an unauthorized alien. (2) *Continuing Employment* It is unlawful for a person or other entity, after hiring an alien for employment in accordance with paragraph (1) to continue to employ the alien in the United States knowing the alien in (or has become) an unauthorized alien with respect to such employment. (4) *Use of labor through contract* For purposes of this section, a person or other entity who uses a contract, subcontract, or exchange, entered into, renegotiated, or extended after November 6, 1986, to obtain the labor of an alien in the United States knowing that the alien is an unauthorized alien (as defined in subsection (h)(3) in this section) with respect to performing such labor, shall be considered to have hired the alien for employment in the United States in violation of paragraph (1)(A).
- .2 **Ut Code 34-30-1. Citizens to be given preference** In employing workmen in the construction of public works by the state or any county or municipality, or by persons contracting with the state or any county or municipality, preference shall be give to citizens of the United States, or those having declared their intention of becoming citizens. In each contract for the construction of public works a provision shall be inserted to the effect that, if the provisions of this section are not complied with, the contract shall be void.
- .3 *Ut Code 34-30-8. Forty-hour work week* Forty hours shall constitute a working week on all works and undertakings carried on by the state, county, or municipal governments, or by any officer of the state or of any county or municipal government. Any persons, corporation, firm, contractor, agent, manager, or foreman, who shall require contract with any person to work upon such works or undertakings longer than 40 hours in one week shall pay such employees at at rate not less than one and one-half times the regular rate at which he is employed. (Piece work rates have to by greater than or equal to minimum wage and one and one-half times minimum wage for hours worked over 40; Minimum wage and overtime laws still apply).
- .4 *Ut Code 34-30-9. Violation of chapter* Any officer, agent, or representative if the state or of any political subdivision, district or municipality of it who shall violate, or omit to comply with any of the provisions of this chapter, and any contractor or subcontractor, or agent or representative thereof, doing such public work, who shall neglect to keep, or cause to be kept, an accurate record of the names, occupation and actual wages paid to each laborer, workman and mechanic employed by him, in connection with this public work or who shall refuse to allow access to same at any reasonable hour to any person authorized to inspect same under this chapter shall be guilty of a misdemeanor.
- .5 **Ut Code 13-47-201. Verification required for new hires** (1) A private employer who employs 15 or more employees as of July 1, 2010, may not hire a new employee on or after July 1, 2010, unless the private employer: (a) is registered with a status verification system to verify the federal legal working status of any new employee; and (b) uses the status verification system to verify the federal legal working status of the new employee in accordance with the requirements of the status verification system. (2) This section does not apply to a private employer of a

foreign national if the foreign national holds a visa issued in response to a petition by the private employer that is classified as H-2A or H-2B.

ARTICLE 15 CLAIMS AND DISPUTES

15.1 Claims

Add this sentence to the end of Subparagraph 15.1.1:

15.1.1 A claim must contain the following explicit language in order to be recognized as a "Claim": "THIS IS A CLAIM AS DEFINED BY CLAUSE 15.1.1 OF AIA DOCUMENT A232."

Modify Subparagraph 15.1.3.1 as follows:

15.1.3.1 Substitute 10 days for 21 days, where the latter occurs in this subparagraph.

END OF SUPPLEMENTARY GENERAL CONDITIONS

HARDWARE GROUP NO. 01 DOOR NUMBER: (INCLUDES BUT IS NOT LIMITED TO THE FOLLOWING DOORS)

1	EA	CYL HOUSING	AS REQ'D BY DOOR MFG		ILC
1	EA	PERMANENT CORE	15395 RA X 1903 SL9 (981	626	ILC
			KEYWAY)		
		REMAINING HARDWARE	BY DOOR MFG/SUPPLIER	626	

HARDWARE GROUP NO. 02 DOOR NUMBER: (INCLUDES BUT IS NOT LIMITED TO THE FOLLOWING DOORS)

3	EA	HINGE	5BB1 4.5 X 4.5 NRP		630	IVE
1	EA	ELECTRIC HINGE	5BB1 4.5 X 4.5 CON TW8	N	652	IVE
1	EA	FSE ELEC LOCK (STOREROOM LOCK)	<u>195-FEU (195 FEU)</u>		626	MKS
1	EA	SURFACE CLOSER	4040XP SCUSH MC TBWMS		689	LCN
1	EA	KICK PLATE	8400 10" X 2" LDW B-CS		630	IVE
1	EA	GASKETING	429AA-S		AA	ZER
1	EA	DOOR SWEEP	39A		A	ZER
1	EA	THRESHOLD	545A-223		A	ZER
1	EA	VIEWER	U696		626	IVE
1	EA	CREDENTIAL READER	BY DIV 28			B/O
1	EA	DOOR CONTACT	679-05HM		BLK	SCE
(1)		POWER SUPPLY	& RELAYS BY DIV 28			B/O

CARD IN. USER PRESENTS CREDENTIAL, ELECTRIFIED LOCKSET LEVER RELEASES, USER OPENS DOOR TO ENTER. DOOR POSITION IS MONITORED BY ACCESS CONTROL/SECURITY SYSTEM.

HARDWARE GROUP NO. 03 DOOR NUMBER: (INCLUDES BUT IS NOT LIMITED TO THE FOLLOWING DOORS)

6	EA	HINGE	5BB1HW 5 X 4.5 NRP	630	IVE
2	EA	MANUAL FLUSH BOLT	FB458	626	IVE
1	EA	DUST PROOF STRIKE	DP2	626	IVE
1	EA	STOREROOM LOCK	195 F	626	MKS
1	EA	PERMANENT CORE	15395 RA X 1903 SL9 (981 KEYWAY)	626	ILC
2	EA	WALL STOP	FS18S (TO BE MOUNTED ON WALL)	BLK	IVE
1	EA	GASKETING	188SBK PSA (ASTRAGAL)	BK	ZER
1	EA	GASKETING	429AA-S	AA	ZER
2	EA	DOOR SWEEP	39A	A	ZER
1	EA	ASTRAGAL	43SP (ACTIVE LEAF, PULL SIDE)	SP	ZER
1	EA	THRESHOLD	545A-223	A	ZER
<u>2</u>	<u>EA</u>	DOOR CONTACT	<u>679-05HM</u>	BLK	SCE

DOOR POSITION IS MONITORED BY ACCESS CONTROL/SECURITY SYSTEM.

HARDWARE GROUP NO. 04 DOOR NUMBER: (INCLUDES BUT IS NOT LIMITED TO THE FOLLOWING DOORS)

3	EA	HINGE	5BB1 4.5 X 4.5 NRP	630	IVE
1	EA	STOREROOM LOCK	195 F	626	MKS
1	EA	SURFACE CLOSER	4040XP HCUSH MC TBWMS	689	LCN
1	EA	KICK PLATE	8400 10" X 2" LDW B-CS	630	IVE
1	EA	GASKETING	429AA-S	AA	ZER
1	EA	DOOR SWEEP	39A	A	ZER
1	EA	THRESHOLD	545A-223	A	ZER
1	$\mathbf{E}\mathbf{A}$	DOOR CONTACT	<u>679-05HM</u>	BLK	SCE

DOOR POSITION IS MONITORED BY ACCESS CONTROL/SECURITY SYSTEM.

HARDWARE GROUP NO. 05 DOOR NUMBER: (INCLUDES BUT IS NOT LIMITED TO THE FOLLOWING DOORS)

3	EA	HINGE	5BB1HW 4.5 X 4.5 NRP	630	IVE
1	EA	PANIC HARDWARE	LD-XP98-EO	626	VON
1	EA	SURFACE CLOSER	4040XP SCUSH MC TBWMS	689	LCN
1	EA	GASKETING	429AA-S	AA	ZER
1	EA	DOOR SWEEP	39A	A	ZER
1	EA	THRESHOLD	545A-223	A	ZER
1	EA	DOOR CONTACT	679-05HM	BLK	SCE

EXIT ONLY. DOOR POSITION IS MONITORED THROUGH ACCESS CONTROL/SECURITY SYSTEM.

HARDWARE GROUP NO. 06

DOOR NUMBER: (INCLUDES BUT IS NOT LIMITED TO THE FOLLOWING DOORS)

(2) Exterior kinder play area gates – refer to Site Development Plans

1	EA	PANIC HARDWARE	LD-XP98-NL-L/TRIM-WH	626	VON
1	EA	RIM CYLINDER	7015RA (981 KEYWAY)	626	ILC
		REMAINING HARDWARE	BY GATE MFG/SUPPLIER		B/O

HARDWARE GROUP NO. 07 DOOR NUMBER: (INCLUDES BUT IS NOT LIMITED TO THE FOLLOWING DOORS)

6	EA	HINGE	5BB1HW 4.5 X 4.5 NRP	630	IVE
1	EA	REMOVABLE MULLION	4954 STAB	689	VON
1	EA	PANIC HARDWARE	LD-XP98-EO	626	VON
1	EA	PANIC HARDWARE	LD-XP98-L-NL-06	626	VON
1	EA	RIM CYLINDER	7015RA (981 KEYWAY)	626	ILC
2	EA	SURFACE CLOSER	4040XP SHCUSH MC TBWMS	689	LCN
1	EA	GASKETING	429AA-S	AA	ZER
1	EA	MULLION SEAL	8780NBK PSA	BK	ZER
2	EA	DOOR SWEEP	39A	A	ZER
1	EA	THRESHOLD	545A-223	A	ZER
2	EA	DOOR CONTACT	679-05HM	BLK	SCE

DOOR POSITION IS MONITORED BY ACCESS CONTROL/SECURITY SYSTEM.

HARDWARE GROUP NO. 08 DOOR NUMBER: (INCLUDES BUT IS NOT LIMITED TO THE FOLLOWING DOORS)

3	EA	HINGE	5BB1HW 5 X 4.5 NRP	630	IVE
1	EA	PANIC HARDWARE	XP98-L-06	626	VON
1	EA	RIM CYLINDER	7015RA (981 KEYWAY)	626	ILC
1	EA	SURFACE CLOSER	4040XP HCUSH MC TBWMS	689	LCN
1	EA	GASKETING	429AA-S	AA	ZER
1	EA	DOOR SWEEP	39A	A	ZER
1	EA	THRESHOLD	545A-223	A	ZER
1	EA	DOOR CONTACT	679-05HM	BLK	SCE

DOOR POSITION IS MONITORED BY ACCESS CONTROL/SECURITY SYSTEM.

HARDWARE GROUP NO. 09 DOOR NUMBER: (INCLUDES BUT IS NOT LIMITED TO THE FOLLOWING DOORS)

3	EA	HINGE	5BB1 4.5 X 4.5 NRP	652	IVE
1	EA	STOREROOM LOCK	195 F	626	MKS
1	EA	PERMANENT CORE	15395 RA X 1903 SL9 (981 KEYWAY)	626	ILC
1	EA	SURFACE CLOSER	4040XP RW/PA MC TBWMS	689	LCN
1	EA	WALL STOP	WS406/407CCV	630	IVE
1	EA	GASKETING	488SBK PSA	BK	ZER

HARDWARE GROUP NO. 10 DOOR NUMBER: (INCLUDES BUT IS NOT LIMITED TO THE FOLLOWING DOORS)

3	EA	HINGE	5BB1 4.5 X 4.5 NRP	652	IVE
1	EA	DEADBOLT	130 K	626	MKS
1	EA	PERMANENT CORE	15395 RA X 1903 SL9 (981	626	ILC
			KEYWAY)		
1	EA	WALL STOP	WS406/407CCV	630	IVE

HARDWARE GROUP NO. 11 DOOR NUMBER: (INCLUDES BUT IS NOT LIMITED TO THE FOLLOWING DOORS)

3	EA	HINGE	5BB1 4.5 X 4.5	652	IVE
1	EA	PRIVACY LATCHSET	195 L	626	MKS
1	EA	SURFACE CLOSER	4040XP RW/PA MC TBWMS	689	LCN
1	EA	KICK PLATE	8400 10" X 2" LDW B-CS	630	IVE
1	EA	WALL STOP	WS406/407CCV	630	IVE
1	EA	GASKETING	488SBK PSA	BK	ZER
1	EA	COAT AND HAT HOOK	543	630	IVE

HARDWARE GROUP NO. 12 DOOR NUMBER: (INCLUDES BUT IS NOT LIMITED TO THE FOLLOWING DOORS)

3	EA	HINGE	5BB1 4.5 X 4.5 NRP	652	IVE
1	EA	KEYED PRIVACY W/DB &	L9496L 06A L583-363	626	SCH
		IND			
1	EA	MORTISE CYLINDER	7185RA (981 KEYWAY)	626	ILC
1	EA	SURFACE CLOSER	4040XP RW/PA MC TBWMS	689	LCN
1	EA	WALL STOP	WS406/407CCV	630	IVE
1	EA	GASKETING	488SBK PSA	BK	ZER
1	EA	COAT AND HAT HOOK	543	630	IVE

HARDWARE GROUP NO. 13 DOOR NUMBER: (INCLUDES BUT IS NOT LIMITED TO THE FOLLOWING DOORS)

3	EA	HINGE	5BB1 4.5 X 4.5	652	IVE
1	EA	KEYED PRIVACY W/DB &	L9496L 06A L583-363	626	SCH
		IND			
1	EA	MORTISE CYLINDER	7185RA (981 KEYWAY)	626	ILC
1	EA	SURFACE CLOSER	4040XP RW/PA MC TBWMS	689	LCN
1	EA	KICK PLATE	8400 10" X 2" LDW B-CS	630	IVE
1	EA	WALL STOP	WS406/407CCV	630	IVE
1	EA	GASKETING	488SBK PSA	BK	ZER
1	EA	COAT AND HAT HOOK	543	630	IVE

HARDWARE GROUP NO. 14 DOOR NUMBER: (INCLUDES BUT IS NOT LIMITED TO THE FOLLOWING DOORS)

3	EA	HINGE	5BB1 4.5 X 4.5	652	IVE
1	EA	FAC RESTRM W/IND	L9486L 06A L583-363 DND	626	SCH
1	EA	MORTISE CYLINDER	7185RA (981 KEYWAY)	626	ILC
1	EA	SURFACE CLOSER	4040XP RW/PA MC TBWMS	689	LCN
1	EA	KICK PLATE	8400 10" X 2" LDW B-CS	630	IVE
1	EA	WALL STOP	WS406/407CCV	630	IVE
1	EA	GASKETING	488SBK PSA	BK	ZER
1	EA	COAT AND HAT HOOK	543	630	IVE

HARDWARE GROUP NO. 15 DOOR NUMBER: (INCLUDES BUT IS NOT LIMITED TO THE FOLLOWING DOORS)

3	EA	HINGE	5BB1HW 5 X 4.5	652	IVE
1	EA	OFF/ENT LOCKSET	195 AB	626	MKS
1	EA	PERMANENT CORE	15395 RA X 1903 SL9 (981 KEYWAY)	626	ILC
1	EA	SURFACE CLOSER	4040XP HW/PA MC TBWMS	689	LCN
1	EA	KICK PLATE	8400 10" X 2" LDW B-CS	630	IVE
1	EA	WALL STOP	WS406/407CCV	630	IVE
3	EA	SILENCER	SR64	GRY	IVE

HARDWARE GROUP NO. 16 DOOR NUMBER: (INCLUDES BUT IS NOT LIMITED TO THE FOLLOWING DOORS)

3	EA	HINGE	5BB1 4.5 X 4.5 NRP	652	IVE
1	EA	OFF/ENT LOCKSET	195 AB	626	MKS
1	EA	PERMANENT CORE	15395 RA X 1903 SL9 (981 KEYWAY)	626	ILC
1	EA	WALL STOP	WS406/407CCV	630	IVE
3	EA	SILENCER	SR64	GRY	IVE

HARDWARE GROUP NO. 17 DOOR NUMBER: (INCLUDES BUT IS NOT LIMITED TO THE FOLLOWING DOORS)

3	EA	HINGE	5BB1 4.5 X 4.5	652	IVE
1	EA	CLASSROOM LOCK	195 S	626	MKS
1	EA	PERMANENT CORE	15395 RA X 1903 SL9 (981 KEYWAY)	626	ILC
1	EA	WALL STOP	WS406/407CCV	630	IVE
3	EA	SILENCER	SR64	GRY	IVE

HARDWARE GROUP NO. 18 DOOR NUMBER: (INCLUDES BUT IS NOT LIMITED TO THE FOLLOWING DOORS)

6	EA	HINGE	5BB1 4.5 X 4.5 NRP	652	IVE
1	EA	AUTO FLUSH BOLT	FB41T	630	IVE
1	EA	CLASSROOM LOCK	195 S	626	MKS
1	EA	PERMANENT CORE	15395 RA X 1903 SL9 (981 KEYWAY)	626	ILC
1	EA	COORDINATOR	COR X FL	628	IVE
1	EA	CARRYBAR	CB1	652	IVE
1	EA	SURFACE CLOSER	4040XP HW/PA MC TBWMS	689	LCN
2	EA	KICK PLATE	8400 10" X 2" LDW B-CS	630	IVE
2	EA	WALL STOP	WS406/407CCV	630	IVE
2	EA	SILENCER	SR64	GRY	IVE

HARDWARE GROUP NO. 19 DOOR NUMBER: (INCLUDES BUT IS NOT LIMITED TO THE FOLLOWING DOORS)

3	EA	HINGE	5BB1 4.5 X 4.5	652	IVE
1	EA	CLASSROOM LOCK	195 S	626	MKS
1	EA	PERMANENT CORE	15395 RA X 1903 SL9 (981 KEYWAY)	626	ILC
1	EA	OH STOP	90S J	630	GLY
3	EA	SILENCER	SR64	GRY	IVE

HARDWARE GROUP NO. 20 DOOR NUMBER: (INCLUDES BUT IS NOT LIMITED TO THE FOLLOWING DOORS)

3	EA	HINGE	5BB1 4.5 X 4.5 NRP	652	IVE
1	EA	CLASSROOM LOCK	195 S	626	MKS
1	EA	PERMANENT CORE	15395 RA X 1903 SL9 (981 KEYWAY)	626	ILC
1	EA	SURFACE CLOSER	4040XP HCUSH MC TBWMS	689	LCN
1	EA	KICK PLATE	8400 10" X 2" LDW B-CS	630	IVE
3	EA	SILENCER	SR64	GRY	IVE

HARDWARE GROUP NO. 21 DOOR NUMBER: (INCLUDES BUT IS NOT LIMITED TO THE FOLLOWING DOORS)

3	EA	HINGE	5BB1 4.5 X 4.5 NRP	652	IVE
1	EA	CLASSROOM LOCK	195 S	626	MKS
1	EA	PERMANENT CORE	15395 RA X 1903 SL9 (981 KEYWAY)	626	ILC
1	EA	SURFACE CLOSER	4040XP HW/PA MC TBWMS	689	LCN
1	EA	KICK PLATE	8400 10" X 2" LDW B-CS	630	IVE
1	EA	WALL STOP	WS406/407CCV	630	IVE
3	EA	SILENCER	SR64	GRY	IVE

HARDWARE GROUP NO. 22 DOOR NUMBER: (INCLUDES BUT IS NOT LIMITED TO THE FOLLOWING DOORS)

3	EA	HINGE	5BB1 4.5 X 4.5	652	IVE
1	EA	CLASSROOM LOCK	195 S	626	MKS
1	EA	PERMANENT CORE	15395 RA X 1903 SL9 (981 KEYWAY)	626	ILC
1	EA	SURFACE CLOSER	4040XP HW/PA MC TBWMS	689	LCN
1	EA	KICK PLATE	8400 10" X 2" LDW B-CS	630	IVE
1	EA	WALL STOP	WS406/407CCV	630	IVE
3	EA	SILENCER	SR64	GRY	IVE

HARDWARE GROUP NO. 23 DOOR NUMBER: (INCLUDES BUT IS NOT LIMITED TO THE FOLLOWING DOORS)

3	EA	HINGE	5BB1 4.5 X 4.5 NRP	652	IVE
1	EA	CLASSROOM LOCK	195 S	626	MKS
1	EA	PERMANENT CORE	15395 RA X 1903 SL9 (981 KEYWAY)	626	ILC
1	EA	WALL STOP	WS406/407CCV	630	IVE
3	EA	SILENCER	SR64	GRY	IVE

HARDWARE GROUP NO. 24 DOOR NUMBER: (INCLUDES BUT IS NOT LIMITED TO THE FOLLOWING DOORS)

3	EA	HINGE	5BB1 4.5 X 4.5 NRP	652	IVE
1	EA	CLASSRM SEC LOCK	195 DB	626	MKS
2	EA	PERMANENT CORE	15395 RA X 1903 SL9 (981 KEYWAY)	626	ILC
1	EA	SURFACE CLOSER	4040XP HEDA MC TBWMS	689	LCN
1	EA	KICK PLATE	8400 10" X 2" LDW B-CS	630	IVE
1	EA	WALL STOP	WS406/407CCV	630	IVE
1	EA	GASKETING	488SBK PSA	BK	ZER

HARDWARE GROUP NO. 25 DOOR NUMBER: (INCLUDES BUT IS NOT LIMITED TO THE FOLLOWING DOORS)

2-(3)	EA	HINGE	5BB1 4.5 X 4.5		652	IVE
<u>1</u>	$\mathbf{E}\mathbf{A}$	ELECTRIC HINGE	5BB1 4.5 X 4.5 CON TW8	N	<u>652</u>	<u>IVE</u>
1	EA	CLASSRM SEC LOCK	195 DB		626	MKS
1	$\mathbf{E}\mathbf{A}$	FSE ELEC LOCK	<u>195-FEU</u>		<u>626</u>	MKS
<u>1-(2)</u>	EA	PERMANENT CORE	15395 RA X 1903 SL9 (981		626	ILC
			KEYWAY)			
1	EA	SURFACE CLOSER	4040XP SHCUSH MC TBWMS		689	LCN
1	EA	KICK PLATE	8400 10" X 2" LDW B-CS		630	IVE
<u>1</u>	$\mathbf{E}\mathbf{A}$	FLOOR MTD MAG	<u>2600</u>		<u>630</u>	ABH
		HOLDER				
1	EA	GASKETING	488SBK PSA		BK	ZER

AUTO LOCK /UNLOCK THROUGH ACCESS CONTROL/SECURITY SYSTEM. DOOR MAY BE HELD OPEN WITH MAG LOCK.UPON LOCKDOWN INITIATION, MAG LOCK WILL RELEASE AND LOCKSET WILL LOCK.

HARDWARE GROUP NO. 26 DOOR NUMBER: (INCLUDES BUT IS NOT LIMITED TO THE FOLLOWING DOORS)

3	EA	HINGE	5BB1HW 5 X 4.5	652	IVE
1	EA	STOREROOM LOCK	195 F	626	MKS
1	EA	PERMANENT CORE	15395 RA X 1903 SL9 (981 KEYWAY)	626	ILC
1	EA	SURFACE CLOSER	4040XP RW/PA MC TBWMS	689	LCN
1	EA	KICK PLATE	8400 10" X 2" LDW B-CS	630	IVE
1	EA	WALL STOP	WS406/407CCV	630	IVE
1	EA	GASKETING	488SBK PSA (DRS A032A, A041A)	BK	ZER
3	EA	SILENCER	SR64	GRY	IVE

HARDWARE GROUP NO. 27 DOOR NUMBER: (INCLUDES BUT IS NOT LIMITED TO THE FOLLOWING DOORS)

3	EA	HINGE	5BB1 4.5 X 4.5	652	IVE
1	EA	STOREROOM LOCK	195 F	626	MKS
1	EA	PERMANENT CORE	15395 RA X 1903 SL9 (981	626	ILC
			KEYWAY)		
1	EA	SURFACE CLOSER	4040XP RW/PA MC TBWMS	689	LCN
1	EA	KICK PLATE	8400 10" X 2" LDW B-CS	630	IVE
1	EA	WALL STOP	WS406/407CCV	630	IVE
1	EA	GASKETING	488SBK PSA	BK	ZER
			(DRS A032A, A041A)		
3	EA	SILENCER	SR64	GRY	IVE

HARDWARE GROUP NO. 28 DOOR NUMBER: (INCLUDES BUT IS NOT LIMITED TO THE FOLLOWING DOORS)

3	EA	HINGE	5BB1 4.5 X 4.5 NRP	652	IVE
1	EA	STOREROOM LOCK	195 F	626	MKS
1	EA	PERMANENT CORE	15395 RA X 1903 SL9 (981 KEYWAY)	626	ILC
1	EA	OH STOP	90S	652	GLY
1	EA	GASKETING	488SBK PSA	BK	ZER

HARDWARE GROUP NO. 29 DOOR NUMBER: (INCLUDES BUT IS NOT LIMITED TO THE FOLLOWING DOORS)

3	EA	HINGE	5BB1 4.5 X 4.5	652	IVE
1	EA	STOREROOM LOCK	195 F	626	MKS
1	EA	PERMANENT CORE	15395 RA X 1903 SL9 (981 KEYWAY)	626	ILC
1	EA	WALL STOP	WS406/407CCV	630	IVE
3	EA	SILENCER	SR64	GRY	IVE

HARDWARE GROUP NO. 30 DOOR NUMBER: (INCLUDES BUT IS NOT LIMITED TO THE FOLLOWING DOORS)

6	EA	HINGE	5BB1 4.5 X 4.5 NRP	652	IVE
1	EA	MANUAL FLUSH BOLT	FB458	626	IVE
			(TOP)		
1	EA	STOREROOM LOCK	195 F	626	MKS
1	EA	PERMANENT CORE	15395 RA X 1903 SL9 (981	626	ILC
			KEYWAY)		
2	EA	WALL STOP	WS406/407CCV	630	IVE
2	EA	SILENCER	SR64	GRY	IVE

HARDWARE GROUP NO. 31 DOOR NUMBER: (INCLUDES BUT IS NOT LIMITED TO THE FOLLOWING DOORS)

3	EA	HINGE	5BB1 4.5 X 4.5	652	IVE
1	EA	STOREROOM LOCK	195 F	626	MKS
1	EA	REMOTE SWITCH	BY DIV 26	\sim	B/O
1	EA	PERMANENT CORE	15395 RA X 1903 SL9 (981 KEYWAY)	626	ILC
1	EA	SURFACE CLOSER	4040XP RW/PA MC TBWMS	689	LCN
1	EA	KICK PLATE	8400 10" X 2" LDW B-CS	630	IVE
1	EA	MAG HOLDER	2100	№ 626	ABH
1	EA	GASKETING	488SBK PSA	BK	ZER

MAGWALL MAGNET MAY BE RELEASED REMOTELY FROM LOCATION TBD.

HARDWARE GROUP NO. 32 DOOR NUMBER: (INCLUDES BUT IS NOT LIMITED TO THE FOLLOWING DOORS)

3	EA	HINGE	5BB1 4.5 X 4.5 NRP	652	IVE
1	EA	STOREROOM LOCK	195 F	626	MKS
1	EA	PERMANENT CORE	15395 RA X 1903 SL9 (981 KEYWAY)	626	ILC
1	EA	WALL STOP	WS406/407CCV	630	IVE
3	EA	SILENCER	SR64	GRY	IVE

HARDWARE GROUP NO. 33 DOOR NUMBER: (INCLUDES BUT IS NOT LIMITED TO THE FOLLOWING DOORS)

3	EA	HINGE	5BB1 4.5 X 4.5 NRP	652	IVE
1	EA	STOREROOM LOCK	195 F	626	MKS
1	EA	PERMANENT CORE	15395 RA X 1903 SL9 (981 KEYWAY)	626	ILC
1	EA	WALL STOP	WS406/407CCV	630	IVE
3	EA	SILENCER	SR64	GRY	IVE

HARDWARE GROUP NO. 34 DOOR NUMBER: (INCLUDES BUT IS NOT LIMITED TO THE FOLLOWING DOORS)

3	EA	HINGE	5BB1HW 4.5 X 4.5 NRP		652	IVE
1	EA	PANIC HARDWARE	LD-98-L-NL-06		626	VON
1	EA	RIM CYLINDER	7015RA (981 KEYWAY)		626	ILC
1	EA	ELECTRIC STRIKE	6300 FSE	×	630	VON
1	EA	SURFACE CLOSER	4040XP SCUSH MC TBWMS		689	LCN
1	EA	KICK PLATE	8400 10" X 2" LDW B-CS		630	IVE
1	EA	WALL STOP	WS406/407CCV		630	IVE
3	EA	SILENCER	SR64		GRY	IVE
1	EA	CREDENTIAL READER	BY DIV 28			B/O
1	EA	DOOR CONTACT	679-05HM		BLK	SCE
1	EA	DOOR POSITION SWITCH	BY DOOR MFG/SUPPLIER	×		B/O

CARD IN. USER PRESENTS CREDENTIAL, ELECTRIC STRIKE KEEPER RELEASES, USER OPENS DOOR TO ENTER. DOOR POSITION IS MONITORED THROUGH ACCESS CONTROL SYSTEM.

HARDWARE GROUP NO. 35 DOOR NUMBER: (INCLUDES BUT IS NOT LIMITED TO THE FOLLOWING DOORS)

3	EA	HINGE	5BB1HW 4.5 X 4.5 NRP		652	IVE
1	EA	POWER TRANSFER	EPT10	N	689	VON
1	EA	DELAYED PANIC HARDWARE	CX98-L-06 24 VDC	×	626	VON
1	EA	RIM CYLINDER	7015RA (981 KEYWAY)		626	ILC
1	EA	MORTISE CYLINDER	7185RA (981 KEYWAY) (ARMING)		626	ILC
1	EA	SURFACE CLOSER	4040XP HEDA MC TBWMS		689	LCN
1	EA	KICK PLATE	8400 10" X 2" LDW B-CS		630	IVE
1	EA	WALL STOP	WS406/407CCV		630	IVE
1	EA	GASKETING	488SBK PSA		BK	ZER
2	EA	CREDENTIAL READER	BY DIV 28			B/O
(1)	(EA)	POWER SUPPLY (POWER SUPPLY)	<u>& RELAYS BY DIV 28 (PS902 900-2RS 120/240 VAC)</u>			B/O (VON)

WHEN ARMED, CARD IN CARD OUT. TO ENTER: USER PRESENTS CREDENTIAL, EXIT DEVICE DELAY AND ALARM IS SHUNTED, EXIT DEVICE TRIM IS RELEASED AND USER DEPRESSES LEVER TO ENTER. TO EXIT: USER PRESENTS CREDENTIAL, EXIT DEVICE DELAY AND ALARM IS SHUNTED, USER PUSHES EXIT DEVICE BAR TO EXIT. UNAUTHORIZED EXIT: USER PUSHES EXIT DEVICE WITHOUT PRESENTING CREDENTIAL. ALARM SOUNDS AND EXITING IS DELAYED FOR 15 SECONDS. INTERFACE IS REQUIRED WITH FIRE-LIFE SAFETY SYSTEM FOR IMMEDIATE RELEASE OF DELAY IN THE EVENT OF A FIRE. WHEN CLASSROOM IS EMPTY, EXIT DEVICE LEVER TRIM CAN BE LOCKED BY KEY WITHOUT ARMING DEVICE.

HARDWARE GROUP NO. 36 DOOR NUMBER: (INCLUDES BUT IS NOT LIMITED TO THE FOLLOWING DOORS)

3	EA	HINGE	5BB1HW 5 X 4.5 NRP	652	IVE
1	EA	PANIC HARDWARE	98-L-NL-06	626	VON
1	EA	RIM CYLINDER	7015RA (981 KEYWAY)	626	ILC
1	EA	SURFACE CLOSER	4040XP RW/PA MC TBWMS	689	LCN
1	EA	WALL STOP	WS406/407CCV	630	IVE
1	EA	GASKETING	488SBK PSA	BK	ZER

HARDWARE GROUP NO. 37 DOOR NUMBER: (INCLUDES BUT IS NOT LIMITED TO THE FOLLOWING DOORS)

3	EA	HINGE	5BB1HW 5 X 4.5 NRP	652	IVE
1	EA	PANIC HARDWARE	98-L-06	626	VON
1	EA	RIM CYLINDER	7015RA (981 KEYWAY)	626	ILC
1	EA	SURFACE CLOSER	4040XP HEDA MC TBWMS	689	LCN
1	EA	KICK PLATE	8400 10" X 2" LDW B-CS	630	IVE
1	EA	WALL STOP	WS406/407CCV	630	IVE
1	EA	GASKETING	488SBK PSA	BK	ZER

HARDWARE GROUP NO. 38 DOOR NUMBER: (INCLUDES BUT IS NOT LIMITED TO THE FOLLOWING DOORS)

3	EA	HINGE	5BB1HW 4.5 X 4.5 NRP	652	IVE
1	EA	PANIC HARDWARE	98-L-06	626	VON
1	EA	RIM CYLINDER	7015RA (981 KEYWAY)	626	ILC
1	EA	SURFACE CLOSER	4040XP HEDA MC TBWMS	689	LCN
1	EA	KICK PLATE	8400 10" X 2" LDW B-CS	630	IVE
1	EA	WALL STOP	WS406/407CCV	630	IVE
1	EA	GASKETING	488SBK PSA	BK	ZER

EXIT DEVICES MAY BE DOGGED BY HEXKEY FOR PUSH/PULL OPERATION.

HARDWARE GROUP NO. 39 DOOR NUMBER: (INCLUDES BUT IS NOT LIMITED TO THE FOLLOWING DOORS)

2-(3)	EA	HINGE	5BB1HW 4.5 X 4.5 NRP		652	IVE
<u>1</u>	$\mathbf{E}\mathbf{A}$	ELECTRIC HINGE	5BB1HW 4.5 X 4.5 TW8	N	<u>652</u>	IVE
1	EA	PANIC HARDWARE	98-L-E996-06-FSE 24 VDC (LD-98-		626	VON
			NL)			
1	EA	RIM CYLINDER	7015RA (981 KEYWAY)		626	ILC
1	EA	SURFACE CLOSER	4040XP RW/PA MC TBWMS		689	LCN
1	EA	KICK PLATE	8400 10" X 2" LDW B-CS		630	IVE
1	EA	MAG HOLDER	2100	N	626	ABH
3	EA	SILENCER	SR64		GRY	IVE

AUTO LOCK /UNLOCK THROUGH ACCESS CONTROL/SECURITY SYSTEM. DOOR MAY BE HELD OPEN WITH MAG LOCK. UPON LOCKDOWN INITIATION, MAG LOCK WILL RELEASE AND EXIT TRIM WILL LOCK. (INTERFACE REQUIRED WITH ACCESS CONTROL/SECURITY SYSTEM FOR IMMEDIATE RELEASE OF WALL MAGNETS IN THE EVENT OF LOCKDOWN.)

HARDWARE GROUP NO.39.1 DOOR NUMBER: (INCLUDES BUT IS NOT LIMITED TO THE FOLLOWING DOORS)

<u>2</u>	$\mathbf{E}\mathbf{A}$	HINGE	<u>5BB1HW 4.5 X 4.5 NRP</u>	<u>652</u>	<u>IVE</u>
<u>1</u>	$\mathbf{E}\mathbf{A}$	ELECTRIC HINGE	5BB1HW 4.5 X 4.5 TW8	★ 652	IVE
<u>1</u>	$\mathbf{E}\mathbf{A}$	PANIC HARDWARE	98-L-E996-06-FSE 24 VDC	<u>626</u>	VON
1	$\mathbf{E}\mathbf{A}$	RIM CYLINDER	7015RA (981 KEYWAY)	<u>626</u>	<u>ILC</u>
<u>1</u>	$\mathbf{E}\mathbf{A}$	SURFACE CLOSER	4040XP RW/PA MC TBWMS	<u>689</u>	LCN
<u>1</u>	$\mathbf{E}\mathbf{A}$	KICK PLATE	8400 10" X 2" LDW B-CS	<u>630</u>	IVE
<u>1</u>	$\mathbf{E}\mathbf{A}$	WALL STOP	WS406/407CCV	<u>630</u>	IVE
<u>3</u>	$\mathbf{E}\mathbf{A}$	SILENCER	<u>SR64</u>	<u>GRY</u>	<u>IVE</u>

AUTO LOCK /UNLOCK THROUGH ACCESS CONTROL/SECURITY SYSTEM.

HARDWARE GROUP NO. 40 DOOR NUMBER: (INCLUDES BUT IS NOT LIMITED TO THE FOLLOWING DOORS)

6	EA	HINGE	5BB1HW 4.5 X 4.5 NRP	652	IVE
<u>1</u>	$\mathbf{E}\mathbf{A}$	POWER TRANSFER	EPT10	№ <u>689</u>	VON
2	EA	PANIC HARDWARE	9849-L-E996-06-FSE-LBL 24 VDC	626	VON
			(9849-L-NL-06)		
2	EA	RIM CYLINDER	7015RA (981 KEYWAY)	626	ILC
1	EA	MORTISE CYLINDER	7185RA (981 KEYWAY)	626	ILC
			(KEYSWITCH)		
2	EA	SURFACE CLOSER	4040XP EDA MC TBWMS	689	LCN
2	EA	KICK PLATE	8400 10" X 2" LDW B-CS	630	IVE
2	EA	400LB WALL MAG	2510	630	ABH
2	EA	SILENCER	SR64	GRY	IVE
1	EA	KEY SWITCH	653-04	626	SCE

AUTO LOCK /UNLOCK THROUGH ACCESS CONTROL/SECURITY SYSTEM. DOOR MAY BE HELD OPEN WITH MAG LOCK .UPON LOCKDOWN INITIATION, MAG LOCK WILL RELEASE AND EXIT TRIM WILL LOCK. KEYSWITCH LOCALLY CONTROL WALL MAGNETS. (INTERFACE REQUIRED WITH ACCESS CONTROL/SECURITY SYSTEM FOR IMMEDIATE RELEASE OF WALL MAGNETS IN THE EVENT OF LOCKDOWN. KEYSWITCH LOCALLY CONTROL WALL MAGNETS.)

HARDWARE GROUP NO. 41 DOOR NUMBER: (INCLUDES BUT IS NOT LIMITED TO THE FOLLOWING DOORS)

3	EA	HINGE	5BB1 4.5 X 4.5 NRP	652	IVE
1	EA	TIME OUT LOCK	ND45 RHO XN12-317	626	SCH
1	EA	WALL STOP	WS406/407CCV	630	IVE
1	EA	GASKETING	488SBK PSA	BK	ZER
1	EA	DOOR SWEEP	39A	A	ZER

HARDWARE GROUP NO. 42 DOOR NUMBER: (INCLUDES BUT IS NOT LIMITED TO THE FOLLOWING DOORS)

2	EA	HINGE	5BB1 4.5 X 4.5 NRP		652	IVE
1	EA	ELECTRIC HINGE	5BB1 4.5 X 4.5 CON TW8	N	652	IVE
1	EA	FSE ELEC LOCK	<u>195-FEU (195-FEU (981 KEYWAY))</u>		626	MKS
1	EA	SURFACE CLOSER	4040XP RW/PA MC TBWMS		689	LCN
1	EA	KICK PLATE	8400 10" X 2" LDW B-CS		630	IVE
1	EA	WALL STOP	WS406/407CCV		630	IVE
3	EA	SILENCER	SR64		GRY	IVE
1	EA	CREDENTIAL READER	BY DIV 28			B/O
		POWER SUPPLY	& RELAYS BY DIV 28			B/O

CARD IN. USER PRESENTS CREDENTIAL, ELECTRIFIED LOCKSET LEVER RELEASES, USER DEPRESSES LEVER TO RETRACT LATCH AND OPEN DOOR.

HARDWARE GROUP NO. A1 DOOR NUMBER: (INCLUDES BUT IS NOT LIMITED TO THE FOLLOWING DOORS)

1	EA	CONT. HINGE	112HD EPT		628	IVE
1	EA	POWER TRANSFER	EPT10	N	689	VON
1	EA	ELEC PANIC HARDWARE	LX-LC-QEL-XP98-NL 24 VDC	N	626	VON
1	EA	RIM CYLINDER	7015RA (981 KEYWAY)		626	ILC
1	EA	OH STOP	100S ADJ		630	GLY
1	EA	4642 CS FC WMS 120 VAC	4642 CS WMS 120 VAC	N	695	LCN
1	EA	ACTUATOR, WALL	8310-853	N	630	LCN
		MOUNT	(EXT WALL)			
1	EA	DUAL BUTTON	8310-855	N	630	LCN
		ACTUATOR	(VESTIBULE WALL)			
1	SET	PERIMETER SEALS	BY DOOR MFG/SUPPLIER		AL	B/O
1	EA	THRESHOLD	BY DOOR MFG/SUPPLIER		AL	
1	EA	CREDENTIAL READER	BY DIV 28			B/O
1	EA	DOOR CONTACT	679-05HM		BLK	SCE
(1)	(EA)	POWER SUPPLY (POWER	<u>& RELAYS BY DIV 28 (PS902 900-</u>			<u>B/O</u>
		SUPPLY)	2RS 120/240 VAC)			(VON)

AUTO LOCK/UNLOCK THROUGH ACCESS CONTROL SYSTEM FOR PUSH/PULL OPERATION DURING NORMAL BUSINESS HOURS. EXTERIOR ACTUATOR TURNED OFF/ON THROUGH ACCESS CONTROL/SECURITY SYSTEM. EXTERIOR OPERATOR FUNCTIONS INDEPENDENT FROM INTERIOR OPERATOR. CARD IN AFTER HOURS. USER PRESENTS CREDENTIAL, EXIT DEVICE RETRACTS AND EXTERIOR ACTUATOR TURNS ON. USER EITHER PUSHES ACTUATOR TO ENGAGE AUTO OPERATOR OR PULLS DOOR TO OPEN. DOOR POSITION IS MONITORED THROUGH ACCESS CONTROL/SECURITY SYSTEM.

HARDWARE GROUP NO. A2 DOOR NUMBER: (INCLUDES BUT IS NOT LIMITED TO THE FOLLOWING DOORS)

1	EA	CONT. HINGE	112HD EPT		628	IVE
1	EA	POWER TRANSFER	EPT10	N	689	VON
1	EA	ELEC PANIC HARDWARE	LX-LC-QEL-XP98-NL 24 VDC	N	626	VON
1	EA	RIM CYLINDER	7015RA (981 KEYWAY)		626	ILC
1	EA	OH STOP	100S ADJ		630	GLY
1	EA	4642 CS FC WMS 120 VAC	4642 CS WMS 120 VAC	N	695	LCN
1	EA	HARDWIRED MULLION	8310-818	N	630	LCN
		ACTUATOR	(PUSH SIDE MULLION)			
1	SET	PERIMETER SEALS	BY DOOR MFG/SUPPLIER		AL	B/O
1	EA	CREDENTIAL READER	BY DIV 28			B/O
1	EA	DOOR CONTACT	679-05HM		BLK	SCE
(1)	(EA)	POWER SUPPLY (POWER	<u>& RELAYS BY DIV 28 (PS902 900-</u>			<u>B/O</u>
		SUPPLY)	2RS 120/240 VAC)			(VON)

AUTO LOCK/UNLOCK THROUGH ACCESS CONTROL SYSTEM FOR PUSH/PULL OPERATION DURING NORMAL BUSINESS HOURS. VESTIBULE ACTUATOR TURNED OFF/ON THROUGH ACCESS CONTROL/SECURITY SYSTEM. EXTERIOR OPERATOR FUNCTIONS INDEPENDENT FROM INTERIOR OPERATOR. CARD IN AFTER HOURS. USER PRESENTS CREDENTIAL, EXIT DEVICE RETRACTS AND VESTIBULE ACTUATOR TURNS ON. USER EITHER PUSHES ACTUATOR TO ENGAGE AUTO OPERATOR OR PULLS DOOR TO OPEN. DOOR POSITION IS MONITORED THROUGH ACCESS CONTROL/SECURITY SYSTEM.

HARDWARE GROUP NO. A3 DOOR NUMBER: (INCLUDES BUT IS NOT LIMITED TO THE FOLLOWING DOORS)

2	EA	CONT. HINGE	112HD EPT		628	IVE
2	EA	POWER TRANSFER	EPT10	N	689	VON
1	EA	REMOVABLE MULLION	4954 STAB		689	VON
2	EA	ELEC PANIC HARDWARE	QEL-XP98-DT	N	626	VON
2	EA	OH STOP	100S ADJ		630	GLY
2	EA	SURFACE CLOSER	4040XP EDAW/62G MC		689	LCN
2	EA	PA MOUNTING PLATE	4040XP-18PA		689	LCN
2	EA	5TH SCREW SUPPORT	4040XP-30		689	LCN
1	SET	PERIMETER SEALS	BY DOOR MFG/SUPPLIER		AL	B/O
1	EA	THRESHOLD	BY DOOR MFG/SUPPLIER		AL	
2	EA	DOOR CONTACT	679-05HM		BLK	SCE
(1)	(EA)	POWER SUPPLY (POWER	<u>& RELAYS BY DIV 28 (PS902 900-</u>			<u>B/O</u>
		SUPPLY)	2RS-120/240 VAC)			(VON)

AUTO LOCK/UNLOCK FOR PUSH/PULL OPERATION. DOOR POSITION IS MONITORED THROUGH ACCESS CONTROL/SECURITY SYSTEM.

HARDWARE GROUP NO. A4 DOOR NUMBER: (INCLUDES BUT IS NOT LIMITED TO THE FOLLOWING DOORS)

1	EA	CONT. HINGE	112HD EPT		628	IVE
1	EA	POWER TRANSFER	EPT10	N	689	VON
1	EA	ELEC PANIC HARDWARE	QEL-XP98-DT	N	626	VON
1	EA	OH STOP	100S ADJ		630	GLY
1	EA	SURFACE CLOSER	4040XP EDAW/62G MC		689	LCN
1	EA	PA MOUNTING PLATE	4040XP-18PA		689	LCN
1	EA	5TH SCREW SUPPORT	4040XP-30		689	LCN
1	SET	PERIMETER SEALS	BY DOOR MFG/SUPPLIER		AL	B/O
1	EA	THRESHOLD	BY DOOR MFG/SUPPLIER		AL	
1	EA	DOOR CONTACT	679-05HM		BLK	SCE
-(1)	(EA)	POWER SUPPLY (POWER	<u>& RELAYS BY DIV 28 (PS902 900-</u>			<u>B/O</u>
		SUPPLY)	2RS 120/240 VAC)			(VON)

AUTO LOCK/UNLOCK FOR PUSH/PULL OPERATION. DOOR POSITION IS MONITORED THROUGH ACCESS CONTROL/SECURITY SYSTEM.

HARDWARE GROUP NO. A5 DOOR NUMBER: (INCLUDES BUT IS NOT LIMITED TO THE FOLLOWING DOORS)

2	EA	CONT. HINGE	112HD EPT		628	IVE
2	EA	POWER TRANSFER	EPT10	N	689	VON
1	EA	REMOVABLE MULLION	4954 STAB		689	VON
2	EA	ELEC PANIC HARDWARE	QEL-XP98-DT	N	626	VON
2	EA	OH STOP	100S ADJ		630	GLY
2	EA	SURFACE CLOSER	4040XP EDAW/62G MC		689	LCN
2	EA	PA MOUNTING PLATE	4040XP-18PA		689	LCN
2	EA	5TH SCREW SUPPORT	4040XP-30		689	LCN
1	SET	PERIMETER SEALS	BY DOOR MFG/SUPPLIER		AL	B/O
(1)	(EA)	POWER SUPPLY (POWER	<u>& RELAYS BY DIV 28 (PS902 900-</u>			<u>B/O</u>
		SUPPLY)	2RS 120/240 VAC)			(VON)

AUTO LOCK/UNLOCK FOR PUSH/PULL OPERATION.

HARDWARE GROUP NO. A6 DOOR NUMBER: (INCLUDES BUT IS NOT LIMITED TO THE FOLLOWING DOORS)

1	EA	CONT. HINGE	112HD EPT		628	IVE
1	EA	POWER TRANSFER	EPT10	N	689	VON
1	EA	ELEC PANIC HARDWARE	QEL-XP98-DT	N	626	VON
1	EA	OH STOP	100S ADJ		630	GLY
1	EA	SURFACE CLOSER	4040XP EDAW/62G MC		689	LCN
1	EA	PA MOUNTING PLATE	4040XP-18PA		689	LCN
1	EA	5TH SCREW SUPPORT	4040XP-30		689	LCN
1	SET	PERIMETER SEALS	BY DOOR MFG/SUPPLIER		AL	B/O
1	EA	DOOR CONTACT	679-05HM		BLK	SCE
(1)	(EA)	POWER SUPPLY (POWER	<u>& RELAYS BY DIV 28 (PS902 900-</u>			<u>B/O</u>
		SUPPLY)	2RS 120/240 VAC)			(VON)

AUTO LOCK/UNLOCK FOR PUSH/PULL OPERATION. DOOR POSITION IS MONITORED THROUGH ACCESS CONTROL/SECURITY SYSTEM.

HARDWARE GROUP NO. A7 DOOR NUMBER: (INCLUDES BUT IS NOT LIMITED TO THE FOLLOWING DOORS)

1	EA	CONT. HINGE	112HD EPT		628	IVE
1	EA	POWER TRANSFER	EPT10	N	689	VON
1	EA	ELEC PANIC HARDWARE	QEL-XP98-NL	N	626	VON
1	EA	RIM CYLINDER	7015RA (981 KEYWAY)		626	ILC
1	EA	OH STOP	100S ADJ		630	GLY
1	EA	SURFACE CLOSER	4040XP EDAW/62G MC		689	LCN
1	EA	PA MOUNTING PLATE	4040XP-18PA		689	LCN
1	EA	5TH SCREW SUPPORT	4040XP-30		689	LCN
1	SET	PERIMETER SEALS	BY DOOR MFG/SUPPLIER		AL	B/O
(1)	(EA)	POWER SUPPLY (POWER	<u>& RELAYS BY DIV 28 (PS902 900-</u>			<u>B/O</u>
		SUPPLY)	2RS 120/240 VAC)			(VON)

EXIT DEVICE LATCHES ARE RETRACTED IN ACCORDANCE WITH TIME/CALENDAR FEATURE OF ACCESS CONTROL/SECURITY SYSTEM FOR PUSH/PULL OPERATION. INTERFACE REQUIRED WITH ACCESS CONTROL/SECURITY SYSTEM FOR IMMEDIATE RELEASE OF LATCHES IN THE EVENT OF LOCKDOWN.

HARDWARE GROUP NO. A8 DOOR NUMBER: (INCLUDES BUT IS NOT LIMITED TO THE FOLLOWING DOORS)

2	EA	CONT. HINGE	112HD EPT		628	IVE
2	EA	POWER TRANSFER	EPT10	N	689	VON
1	EA	REMOVABLE MULLION	4954 STAB		689	VON
1	EA	ELEC PANIC HARDWARE	QEL-XP98-DT	N	626	VON
1	EA	ELEC PANIC HARDWARE	QEL-XP98-NL	N	626	VON
1	EA	RIM CYLINDER	7015RA (981 KEYWAY)		626	ILC
2	EA	OH STOP	100S ADJ		630	GLY
2	EA	SURFACE CLOSER	4040XP EDAW/62G MC		689	LCN
2	EA	PA MOUNTING PLATE	4040XP-18PA		689	LCN
2	EA	5TH SCREW SUPPORT	4040XP-30		689	LCN
1	SET	PERIMETER SEALS	BY DOOR MFG/SUPPLIER		AL	B/O
1	EA	THRESHOLD	BY DOOR MFG/SUPPLIER		AL	
1	EA	CREDENTIAL READER	BY DIV 28			B/O
2	EA	DOOR CONTACT	679-05HM		BLK	SCE
(1)	(EA)	POWER SUPPLY (POWER	<u>& RELAYS BY DIV 28 (PS902 900-</u>			<u>B/O</u>
		SUPPLY)	2RS 120/240 VAC)			(VON)

AUTOLOCK/UNLOCK FOR PUSH/PULL OPERATION. AFTER HOURS CARD IN. USER PRESENTS CREDENTIAL, LATCH RETRACTS ON EXIT DEVICE, USER OPENS DOOR TO ENTER. DOOR POSITION IS MONITORED THROUGH ACCESS CONTROL/SECURITY SYSTEM.

HARDWARE GROUP NO. A9 DOOR NUMBER: (INCLUDES BUT IS NOT LIMITED TO THE FOLLOWING DOORS)

1	EA	CONT. HINGE	<u>112HD EPT (112HD)</u>	6	528	IVE
<u>1</u>	$\mathbf{E}\mathbf{A}$	POWER TRANSFER	<u>EPT10</u>	№ 6	<u> </u>	VON
1	EA	PANIC HARDWARE	98-L-E996-06-FSE 24 VDC (LD-98-	6	526	VON
			NL)			
1	EA	RIM CYLINDER	7015RA (981 KEYWAY)	6	526	ILC
1	EA	MORTISE CYLINDER	7185RA (981 KEYWAY)	6	526	ILC
			(KEYSWITCH)			
1	EA	SURFACE CLOSER	4040XP EDAW/62G MC TBWMS	6	589	LCN
1	EA	PA MOUNTING PLATE	4040XP-18PA	6	589	LCN
1	EA	5TH SCREW SUPPORT	4040XP-30	6	589	LCN
1	EA	400LB WALL MAG	2510	6	530	ABH
1	SET	PERIMETER SEALS	BY DOOR MFG/SUPPLIER	A	A L	B/O
1	EA	KEY SWITCH	653-04	6	526	SCE
		POWER SUPPLY	& RELAYS BY DIV 28			B/O

AUTO LOCK /UNLOCK THROUGH ACCESS CONTROL/SECURITY SYSTEM. DOOR MAY BE HELD OPEN WITH MAG LOCK.UPON LOCKDOWN INITIATION, MAG LOCK WILL RELEASE AND EXIT TRIM WILL LOCK. (INTERFACE REQUIRED WITH ACCESS CONTROL/SECURITY SYSTEM FOR IMMEDIATE RELEASE OF WALL MAGNETS IN THE EVENT OF LOCKDOWN. KEYSWITCH LOCALLY CONTROLS WALL MAGNETS.)

HARDWARE GROUP NO. A10 DOOR NUMBER: (INCLUDES BUT IS NOT LIMITED TO THE FOLLOWING DOORS)

1	EA	CONT. HINGE	<u>112HD EPT (112HD)</u>		628	IVE
<u>1</u>	$\mathbf{E}\mathbf{A}$	POWER TRANSFER	EPT10	N	<u>689</u>	VON
1	EA	PANIC HARDWARE	98-L-E996-06-FSE 24 VDC (LD-98-		626	VON
			DT)			
1	EA	SURFACE CLOSER	4040XP EDAW/62G MC TBWMS		689	LCN
1	EA	PA MOUNTING PLATE	4040XP-18PA		689	LCN
1	EA	5TH SCREW SUPPORT	4040XP-30		689	LCN
1	EA	400LB WALL MAG	2510		630	ABH
1	SET	PERIMETER SEALS	BY DOOR MFG/SUPPLIER		AL	B/O
		POWER SUPPLY	& RELAYS BY DIV 28			B/O
		REFER TO COMPANION	FOR KEYSWITCH AND POWER	N		
		DOOR	SUPPLY			

AUTO LOCK /UNLOCK THROUGH ACCESS CONTROL/SECURITY SYSTEM. DOOR MAY BE HELD OPEN WITH MAG LOCK.UPON LOCKDOWN INITIATION, MAG LOCK WILL RELEASE AND LOCKSET WILL LOCK. (INTERFACE REQUIRED WITH ACCESS CONTROL/SECURITY SYSTEM FOR IMMEDIATE RELEASE OF WALL MAGNETS IN THE EVENT OF LOCKDOWN. KEYSWITCH LOCALLY CONTROLS WALL MAGNETS.)

HARDWARE GROUP NO. A11 DOOR NUMBER: (INCLUDES BUT IS NOT LIMITED TO THE FOLLOWING DOORS)

1	EA	CONT. HINGE	112HD EPT		628	IVE
1	EA	POWER TRANSFER	EPT10	×	689	VON
1	EA	ELEC PANIC HARDWARE	QEL-98-NL 24 VDC	N	626	VON
1	EA	RIM CYLINDER	7015RA (981 KEYWAY)		626	ILC
1	EA	SURFACE CLOSER	4040XP EDAW/62G MC TBWMS		689	LCN
1	EA	PA MOUNTING PLATE	4040XP-18PA		689	LCN
1	EA	5TH SCREW SUPPORT	4040XP-30		689	LCN
1	EA	MAG HOLDER	2100	N	626	ABH
1	SET	PERIMETER SEALS	BY DOOR MFG/SUPPLIER		AL	B/O
-(1)	(EA)	POWER SUPPLY (POWER	<u>& RELAYS BY DIV 28 (PS902 900-</u>			<u>B/O</u>
		SUPPLY)	2RS 120/240 VAC)			(VON)

EXIT DEVICE LATCHES ARE RETRACTED IN ACCORDANCE WITH TIME/CALENDAR FEATURE OF ACCESS CONTROL/SECURITY SYSTEM FOR PUSH/PULL OPERATION. INTERFACE REQUIRED WITH ACCESS CONTROL/SECURITY SYSTEM FOR IMMEDIATE RELEASE OF WALL MAGNETS IN THE EVENT OF LOCKDOWN.

HARDWARE GROUP NO. A12 DOOR NUMBER: (INCLUDES BUT IS NOT LIMITED TO THE FOLLOWING DOORS)

1	EA	SLIDING DOOR	BI-PARTING SLIDE SYSTEM SECTION 08 4313		ADS
1	EA	MORTISE CYLINDER	7185RA (981 KEYWAY)	626	ILC
		REMAINING HARDWARE	BY DOOR MFG/SUPPLIER	626	

HARDWARE GROUP NO. B1 DOOR NUMBER: (INCLUDES BUT IS NOT LIMITED TO THE FOLLOWING DOORS)

2	EA	CONT. HINGE	112HD	628	IVE
2	EA	DUMMY PUSH BAR	350-DT-990	626	VON
2	EA	OH STOP	100S ADJ	630	GLY
2	EA	SURFACE CLOSER	4040XP EDAW/62G MC	689	LCN
2	EA	PA MOUNTING PLATE	4040XP-18PA	689	LCN
2	EA	5TH SCREW SUPPORT	4040XP-30	689	LCN
1	SET	PERIMETER SEALS	BY DOOR MFG/SUPPLIER	AL	B/O

HARDWARE GROUP NO. B2 DOOR NUMBER: (INCLUDES BUT IS NOT LIMITED TO THE FOLLOWING DOORS)

1	EA	CONT. HINGE	112HD	628	IVE
1	EA	DUMMY PUSH BAR	350-DT-990	626	VON
1	EA	SURFACE CLOSER	4040XP EDAW/62G MC	689	LCN
1	EA	PA MOUNTING PLATE	4040XP-18PA	689	LCN
1	EA	5TH SCREW SUPPORT	4040XP-30	689	LCN
1	EA	WALL STOP	WS406/407CCV	630	IVE
1	SET	PERIMETER SEALS	BY DOOR MFG/SUPPLIER	AL	B/O

HARDWARE GROUP NO. B3 DOOR NUMBER: (INCLUDES BUT IS NOT LIMITED TO THE FOLLOWING DOORS)

1	EA	CONT. HINGE	112HD	628	IVE
1	EA	DUMMY PUSH BAR	350-DT-990	626	VON
1	EA	OH STOP	100S ADJ	630	GLY
1	EA	SURFACE CLOSER	4040XP EDAW/62G MC	689	LCN
1	EA	PA MOUNTING PLATE	4040XP-18PA	689	LCN
1	EA	5TH SCREW SUPPORT	4040XP-30	689	LCN
1	SET	PERIMETER SEALS	BY DOOR MFG/SUPPLIER	AL	B/O

HARDWARE GROUP NO. C1 DOOR NUMBER: (INCLUDES BUT IS NOT LIMITED TO THE FOLLOWING DOORS)

1	EA	CONT. HINGE	112HD	628	IVE
1	EA	STOREROOM LOCK	195 F	626	MKS
1	EA	PERMANENT CORE	15395 RA X 1903 SL9 (981 KEYWAY)	626	ILC
1	EA	ELECTRIC STRIKE	6211AL FSE 12/16/24/28 VAC/VDC	№ 630	VON
1	EA	SURF. AUTO OPERATOR	4631 CS WMS 120 VAC	№ 689	LCN
1	EA	HARDWIRED MULLION	8310-818	№ 630	LCN
		ACTUATOR	(PUSH SIDE MULLION)		
1	EA	ACTUATOR, WALL	8310-853	№ 630	LCN
		MOUNT	(VESTIBULE WALL)		
1	EA	WALL STOP	WS406/407CCV	630	IVE
1	SET	PERIMETER SEALS	BY DOOR MFG/SUPPLIER	AL	B/O
1	EA	CREDENTIAL READER	BY DIV 28		B/O
		POWER SUPPLY	& RELAYS BY DIV 28		B/O
1	EA	REMOTE SWITCH	BY DIVISION 26	M	

AUTO LOCK/UNLOCK THROUGH ACCESS CONTROL /SECURITY SYSTEM DURING NORMAL BUSINESS HOURS. EXTERIOR ACTUATOR TURNED OFF/ON THROUGH ACCESS CONTROL SYSTEM. DOOR POSITION IS MONITORED THROUGH ACCESS CONTROL SYSTEM. MOTION DETECTOR IS REQUEST TO EXIT. CARD IN WHEN LOCKED. USER PRESENTS CREDENTIAL, ELECTRIC STRIKE KEEPER RELEASES, AND VESTIBULE ACTUATOR TURNS ON. USER EITHER PUSHES ACTUATOR TO ENGAGE AUTO OPERATOR OR PUSHES DOOR TO OPEN. ELECTRIC STRIKE AND VESTIBULE ACTUATOR MAY BE REMOTELY RELEASED FROM ADMINISTRATION.

HARDWARE GROUP NO. C2 DOOR NUMBER: (INCLUDES BUT IS NOT LIMITED TO THE FOLLOWING DOORS)

1	EA	CONT. HINGE	<u>112HD EPT (112HD)</u>		628	IVE
<u>1</u>	$\mathbf{E}\mathbf{A}$	POWER TRANSFER	EPT10	N	<u>689</u>	VON
1	EA	FSE ELEC LOCK	<u>195-FEU (195 DC)</u>		626	MKS
		(COMMUNICATING LOCK)				
<u>1-(2)</u>	EA	PERMANENT CORE	15395 RA X 1903 SL9 (981		626	ILC
			KEYWAY)			
4	EA	ELECTRIC STRIKE	6211AL FSE 12/16/24/28 VAC/VDC	N	630	VON
<u>1</u>	$\mathbf{E}\mathbf{A}$	OH STOP	100S ADJ		<u>630</u>	GLY
1	EA	SURFACE CLOSER	4040XP EDAW/62G MC		689	LCN
1	EA	PA MOUNTING PLATE	4040XP-18PA		689	LCN
1	EA	5TH SCREW SUPPORT	4040XP-30		689	LCN
4	EA	WALL STOP	WS406/407CCV		630	IVE
1	SET	PERIMETER SEALS	BY DOOR MFG/SUPPLIER		AL	B/O
		POWER SUPPLY	& RELAYS BY DIV 28			B/O
4	EA	REMOTE SWITCH	BY DIVISION 26	N		

AUTO LOCK/UNLOCK IN ACCORDANCE WITH TIME AND CALENDAR FEATURE OF ACCESS CONTROL/SECURITY SYSTEM. MAY BE ON LOCKDOWN SCENARIO. (EITHER LEVER MAY BE LOCKED OR UNLOCKED INDEPENDENTLY. WHEN LOCKED, ELECTRIC STRIKE MAY BE RELEASED REMOTELY FROM LOCATIONS TBD.)

HARDWARE GROUP NO. C3 DOOR NUMBER: (INCLUDES BUT IS NOT LIMITED TO THE FOLLOWING DOORS) A162A

1	EA	CONT. HINGE	112HD	628	IVE
1	EA	CLASSROOM LOCK	195 S	626	MKS
1	EA	PERMANENT CORE	15395 RA X 1903 SL9 (981 KEYWAY)	626	ILC
1	EA	OH STOP	100S ADJ	630	GLY
1	SET	PERIMETER SEALS	BY DOOR MFG/SUPPLIER	AL	B/O

HARDWARE GROUP NO. C4 DOOR NUMBER: (INCLUDES BUT IS NOT LIMITED TO THE FOLLOWING DOORS)

1	EA	CONT. HINGE	112HD	628	IVE
1	EA	CLASSRM SEC LOCK	195 DB	626	MKS
2	EA	PERMANENT CORE	15395 RA X 1903 SL9 (981 KEYWAY)	626	ILC
1	EA	SURFACE CLOSER	4040XP HEDA/62G MC	689	LCN
1	EA	PA MOUNTING PLATE	4040XP-18PA	689	LCN
1	EA	5TH SCREW SUPPORT	4040XP-30	689	LCN
1	EA	WALL STOP	WS406/407CCV	630	IVE
1	SET	PERIMETER SEALS	BY DOOR MFG/SUPPLIER	AL	B/O

DOOR MAY BE HELD OPEN USING HOLD OPEN FEATURE OF CLOSER ARM. CLASSROOM SECURITY LOCKSET MAY BE LOCKED FROM THE INTERIOR SIDE OF THE CLASSROOM FOR LOCKDOWN.

HARDWARE GROUP NO. C5 DOOR NUMBER: (INCLUDES BUT IS NOT LIMITED TO THE FOLLOWING DOORS)

1	EA	CONT. HINGE	112HD	628	IVE
1	EA	CLASSROOM LOCK	195 S	626	MKS
1	EA	PERMANENT CORE	15395 RA X 1903 SL9 (981 KEYWAY)	626	ILC
1	EA	WALL STOP	WS406/407CCV	630	IVE
1	SET	PERIMETER SEALS	BY DOOR MFG/SUPPLIER	AL	B/O

HARDWARE GROUP NO. C6 DOOR NUMBER: (INCLUDES BUT IS NOT LIMITED TO THE FOLLOWING DOORS)

1	EA	CONT. HINGE	112HD	628	IVE
1	EA	DBL CYL DEADBOLT	130 M	626	MKS
2	EA	PERMANENT CORE	15395 RA X 1903 SL9 (981 KEYWAY)	626	ILC
1	EA	OH STOP	100S ADJ	630	GLY
1	EA	SURFACE CLOSER	4040XP EDAW/62G MC TBWMS	689	LCN
1	EA	PA MOUNTING PLATE	4040XP-18PA	689	LCN
1	EA	5TH SCREW SUPPORT	4040XP-30	689	LCN
1	SET	PERIMETER SEALS	BY DOOR MFG/SUPPLIER	AL	B/O
1	EA	THRESHOLD	BY DOOR MFG/SUPPLIER	AL	
1	EA	DOOR CONTACT	679-05HM	BLK	SCE

DOOR POSITION IS MONITORED BY ACCESS CONTROL/SECURITY SYSTEM.

HARDWARE GROUP NO. D1 DOOR NUMBER: (INCLUDES BUT IS NOT LIMITED TO THE FOLLOWING DOORS)

2	SET	PIVOT & CLOSER	BY DOOR MFG	626	B/O
2	EA	EXIT DEVICE	PA100F4RKBS	630	CRL
2	EA	RIM CYLINDER	7015RA (981 KEYWAY)	626	ILC
1	EA	MORTISE CYLINDER	7185RA (981 KEYWAY)	626	ILC
			(KEYSWITCH)		
1	EA	ELECTRIC STRIKE	ESK2BS	630	CRL
2	EA	CUSTOM BOLLARD	BY OTHERS	\bowtie	TBD
2	EA	400LB WALL MAG	2510	630	ABH
			(LOCATED IN BOLLARD)		
1	SET	PERIMETER SEALS	BY DOOR MFG/SUPPLIER	AL	B/O
1	EA	KEY SWITCH	653-04	626	SCE
			(LOCATED IN BOLLARD)		
		REMAINING HARDWARE	BY DOOR MFG/SUPPLIER	626	

AUTO LOCK/UNLOCK OF ELECTRIC STRIKES IN ACCORDANCE WITH TIME /CALENDAR FEATURE OF ACCESS CONTROL/SECURITY SYSTEM. INTERFACE REQUIRED WITH ACCESS CONTROL/SECURITY SYSTEM FOR IMMEDIATE RELEASE OF MAGNETS IN A LOCKDOWN EVENT. KEYSWITCH LOCALLY CONTROLS WALL MAGNETS.

SECTION 09 0561

COMMON WORK RESULTS FOR FLOORING PREPARATION

PART 1 GENERAL

1.01 SECTION INCLUDES

- A. This section applies to all floors identified in the contract documents as to receive the following types of floor coverings:
 - 1. Resilient Athletic flooring.
 - 2. Broadloom carpet.
 - 3. Carpet tile.
 - 4. Entrance flooring.
 - 5. Ceramic tile.
- B. Preparation of new concrete floor slabs for installation of floor coverings.
- C. Testing of concrete floor slabs for moisture and pH.
- D. Do not include sales tax, refer to Section 00 0102 Notice to Contractors.

1.02 RELATED REQUIREMENTS

- A. Section 01 2200 Unit Prices: Bid pricing for remediation treatments if required.
- B. Section 01 4000 Quality Requirements: Additional requirements relating to testing agencies and testing.
- Section 03 3000 Cast-In-Place Concrete: Limitations on curing requirements for new concrete floor slabs.

1.03 PRICE AND PAYMENT PROCEDURES

- A. Unit Prices: See Section 01 2200 Unit Prices.
- B. Unit Price for Alternate Flooring Adhesive: Do not include the cost of the alternate adhesive in the base bid; state on the bid form the unit price per square foot (square meter) for using the alternate adhesive, in the event high moisture adhesive is required.

1.04 ADMINISTRATIVE REQUIREMENTS

A. Coordinate scheduling of cleaning and testing, so that preliminary cleaning has been completed for at least 24 hours prior to testing.

1.05 SUBMITTALS

- A. Floor Covering and Adhesive Manufacturers' Product Literature: For each specific combination of substrate, floor covering, and adhesive to be used; showing:
 - Moisture and pH limits and test methods.
 - 2. Manufacturer's required bond/compatibility test procedure.
- B. Testing Agency's Report: Include:
 - 1. Description of areas tested; include floor plans and photographs if helpful.

- 2. Summary of conditions encountered.
- 3. Moisture and pH test reports.
- 4. Copies of specified test methods.
- 5. Recommendations for remediation of unsatisfactory surfaces.
- 6. Include certification of accuracy by authorized official of testing agency.
- 7. Submit report to Architect.
- 8. Submit report not more than two business days after conclusion of testing.
- C. Adhesive Bond and Compatibility Test Report.

1.06 QUALITY ASSURANCE

- A. Moisture and pH testing will be performed by an independent testing agency employed and paid by Granite School District.
 - Contractor shall schedule testing.
- B. Contractor's Responsibility Relating to Independent Agency Testing:
 - 1. Provide access for and cooperate with testing agency.
 - 2. Confirm date of start of testing at least 10 days prior to actual start.
 - 3. Allow at least 4 business days on site for testing agency activities.
 - 4. Achieve and maintain specified ambient conditions.
 - 5. Notify Architect when specified ambient conditions have been achieved and when testing will start.

1.07 FIELD CONDITIONS

- A. Maintain ambient temperature in spaces where concrete testing is being performed, and for at least 48 hours prior to testing, at not less than 65 degrees F (18 degrees C) or more than 85 degrees F (30 degrees C).
- B. Maintain relative humidity in spaces where concrete testing is being performed, and for at least 48 hours prior to testing, at not less than 40 percent and not more than 60 percent.

1.08 GUARANTEE

A. The Contractor shall guarantee his work for a period of 5 years from date of Substantial Completion. Guarantee shall be on form included in Section 01 7800.

PART 2 PRODUCTS

2.01 MATERIALS

- A. Patching Compound: Floor covering manufacturer's recommended product, suitable for conditions, and compatible with adhesive and floor covering. In the absence of any recommendation from flooring manufacturer, provide a product with the following characteristics:
 - Cementitious moisture-, mildew-, and alkali-resistant compound, compatible with floor, floor covering, and floor covering adhesive, and capable of being feathered to nothing at edges.
 - 2. Latex or polyvinyl acetate additions are permitted; gypsum content is prohibited.
 - 3. Compressive Strength: 3000 psi, minimum, after 28 days, when tested in accordance with ASTM C109/C109M or ASTM C472, whichever is appropriate.
- B. Alternate Flooring Adhesive: Floor covering manufacturer's recommended product, suitable for concrete slab relative humidity moisture up to 95 percent; low-VOC. In the absence of any

recommendation from flooring manufacturer, provide a product recommended by adhesive manufacturer as suitable for substrate and floor covering.

PART 3 EXECUTION

3.01 CONCRETE SLAB PREPARATION

- A. Follow recommendations of testing agency.
- B. Perform following operations in the order indicated:
 - Preliminary cleaning.
 - 2. Moisture vapor emission tests; 3 tests in the first 1000 square feet (100 square meters) and one test in each additional 1000 square feet (100 square meters), unless otherwise indicated or required by flooring manufacturer.
 - 3. Internal relative humidity tests; in same locations as moisture vapor emission tests, unless otherwise indicated.
 - 4. pH tests; in same locations as moisture vapor emission tests, unless otherwise indicated.
 - Specified remediation, if required.
 - 6. Patching, smoothing, and leveling, as required.
 - 7. Other preparation specified.
 - 8. Adhesive bond and compatibility test.
 - 9. Protection.

C. Remediations:

- Active Water Leaks or Continuing Moisture Migration to Surface of Slab: Correct this
 condition before doing any other remediation; re-test after correction.
- 2. Excessive Moisture Emission or Relative Humidity: Contact architect in writing and use alternate flooring adhesive.
- 3. Excessive pH: Contact architect in writing and use adhesive that is resistant to the level present and acceptable to the flooring manufacturer; otherwise, apply a skim coat of specified patching compound over entire suspect floor area.

3.02 PRELIMINARY CLEANING

- A. Clean floors of dust, solvents, paint, wax, oil, grease, asphalt, residual adhesive, adhesive removers, film-forming curing compounds, sealing compounds, alkaline salts, excessive laitance, mold, mildew, and other materials that might prevent adhesive bond.
- B. Do not use solvents or other chemicals for cleaning.

3.03 MOISTURE VAPOR EMISSION TESTING

- A. Where the floor covering manufacturer's requirements conflict with either the referenced test method or this specification, comply with the manufacturer's requirements.
- B. Where this specification conflicts with the referenced test method, comply with the requirements of this section.
- C. Test in accordance with ASTM F1869 and as follows.
- D. Plastic sheet test and mat bond test may not be substituted for the specified ASTM test method, as those methods do not quantify the moisture content sufficiently.

- E. In the event that test values exceed floor covering manufacturer's limits, perform remediation as indicated. In the absence of manufacturer limits, perform remediation if test values exceed 3 pounds per 1000 square feet (1.4 kg per 93 square meters) per 24 hours.
- F. Report: Report the information required by the test method.

3.04 PH TESTING

- A. Where the floor covering manufacturer's requirements conflict with either the referenced test method or this specification, comply with the manufacturer's requirements.
- B. Note: This procedure is the equivalent of that described in ASTM F710, repeated here for the Contractor's convenience.
- C. Use a wide range pH paper, its associated chart, and distilled or deionized water.
- D. Place several drops of water on a clean surface of concrete, forming a puddle approximately 1 inch (25 mm) in diameter. Allow the puddle to set for approximately 60 seconds, then dip the pH paper into the water, remove it, and compare immediately to chart to determine pH reading.
- E. In the event that test values exceed floor covering manufacturer's limits, perform remediation as indicated. In the absence of manufacturer limits, perform remediation if any test value is over 10.

3.05 PREPARATION

- A. See individual floor covering section(s) for additional requirements.
- B. Comply with requirements and recommendations of floor covering manufacturer.
- C. Fill and smooth surface cracks, grooves, depressions, control joints and other non-moving joints, and other irregularities with patching compound.
- D. Do not fill expansion joints, isolation joints, or other moving joints.

3.06 ADHESIVE BOND AND COMPATIBILITY TESTING

A. Comply with requirements and recommendations of floor covering manufacturer.


3.07 APPLICATION OF REMEDIAL FLOOR COATING

A. Comply with requirements and recommendations of coating manufacturer.

3.08 PROTECTION

A. Cover prepared floors with building paper or other durable covering.

END OF SECTION

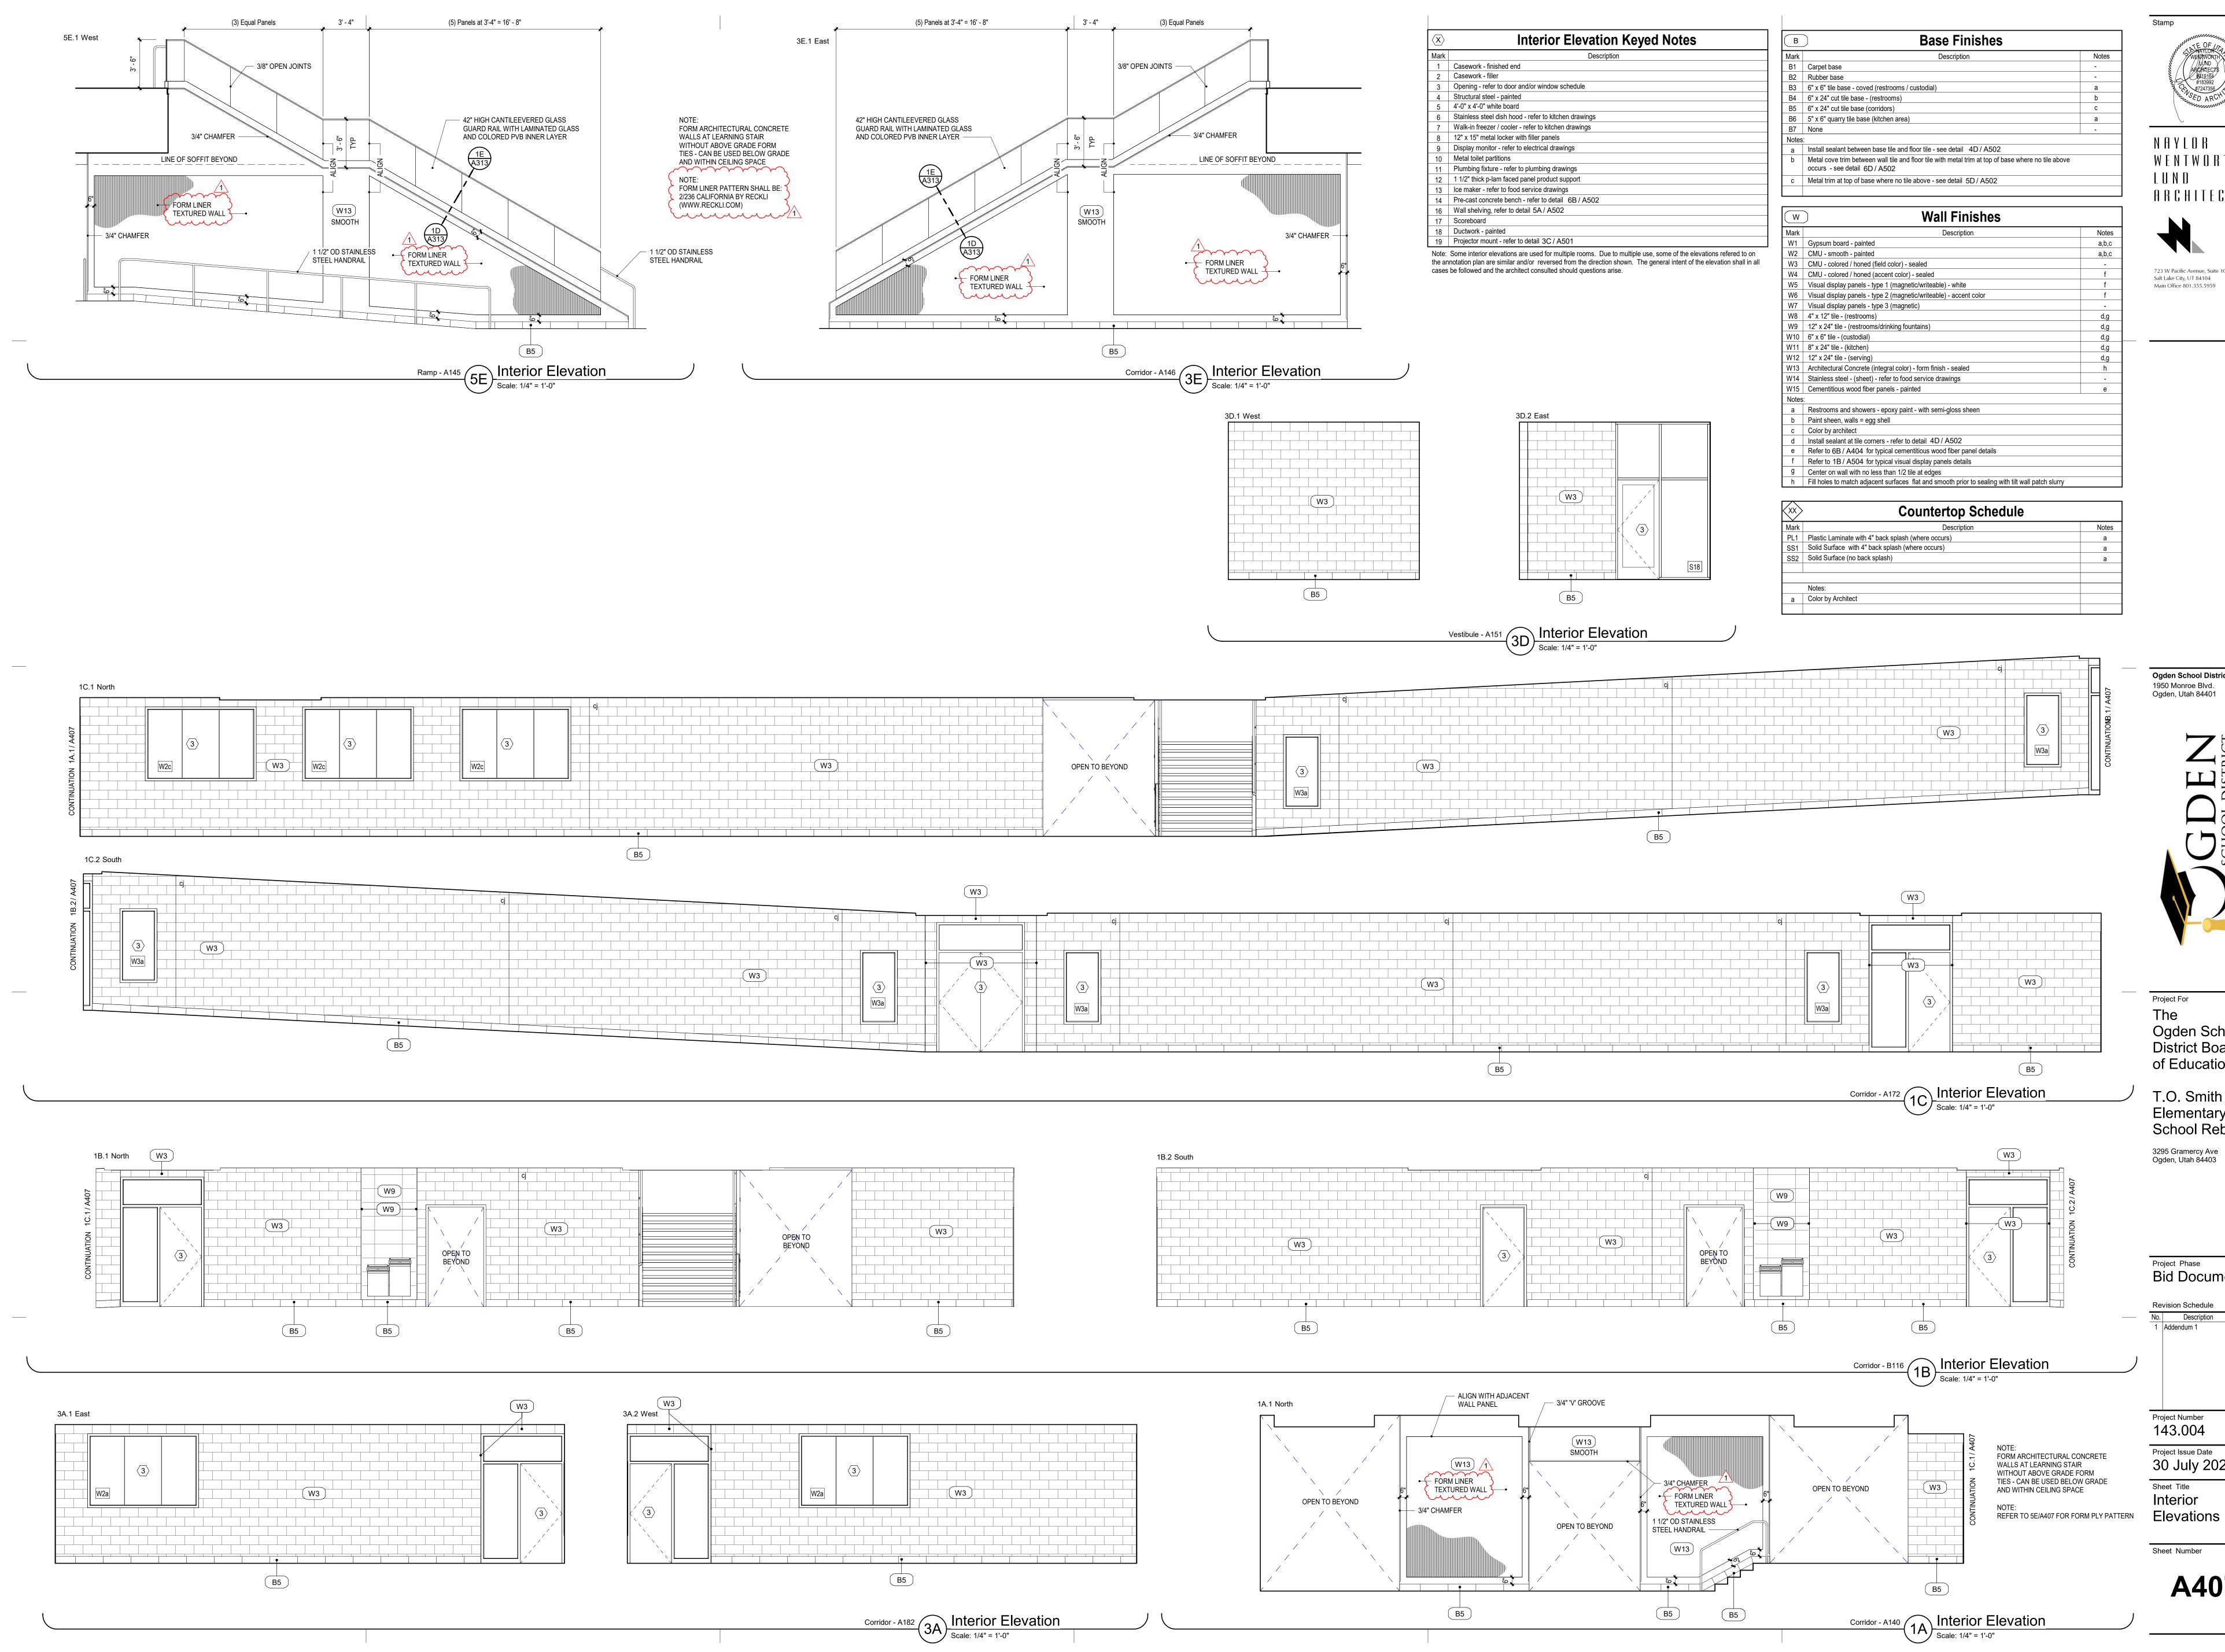

NAYLOR WENTWORTH ARCHITECTS



723 W Pacific Avenue, Suite 101 Salt Lake City, UT 84104 Main Office 801.355.5959

Ogden School District

The Ogden School District Board of Education

Elementary School Rebuild

Project Phase
Bid Documents


Project Issue Date

30 July 2020

Elevations

Sheet Number

A407

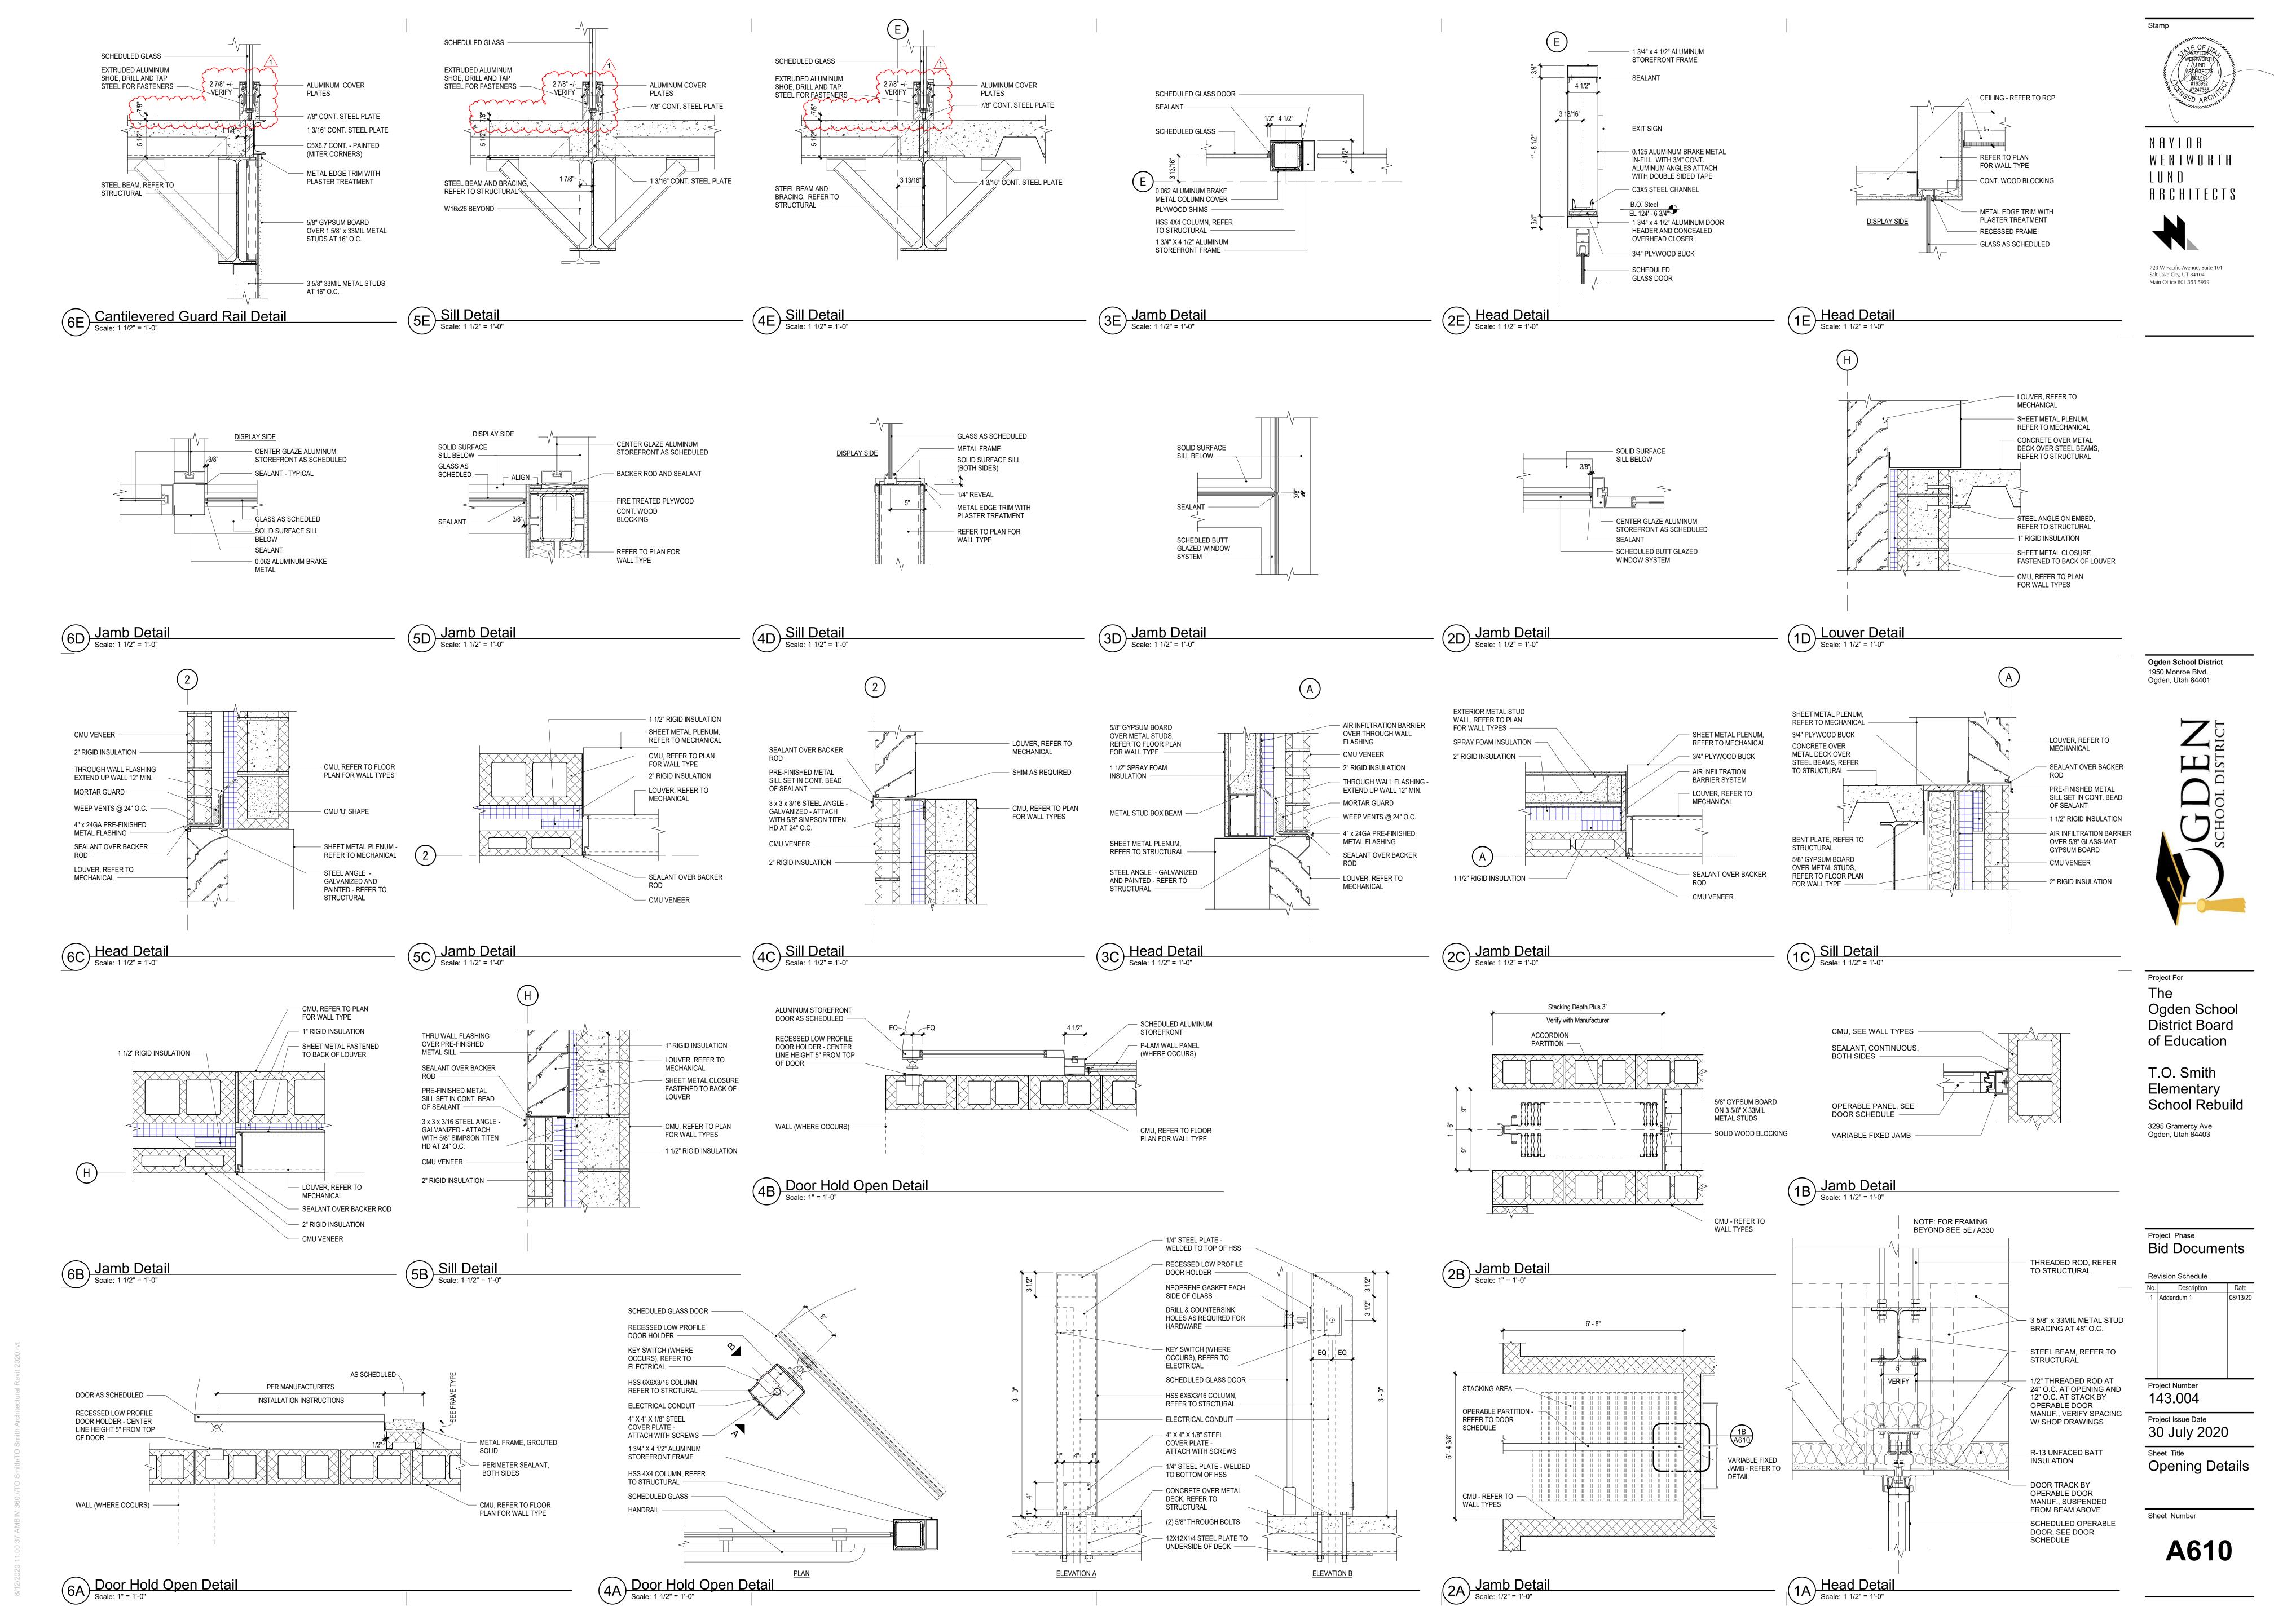



ADDENDUM 1

Date: 8/13/2020 Client: NWL Architects

Project: T.O. Smith Elementary School Rebuild

By: Marc Shields

Structural Narrative of Addendum No.1


S503

• Changed stud connector note on details B1, B2, B3, C2 and C3 so they are uniform and correctly reference detail D1/S507.

S504

- Changed stud connector note on detail D3 to be uniform with details on S503.
- Changed stud note on D3 to call out exterior stud size.

- Changed stud connector note on details B1 and D6 so they are uniform with details on S503.
- Changed joist load note on detail A5 to match plan notes.

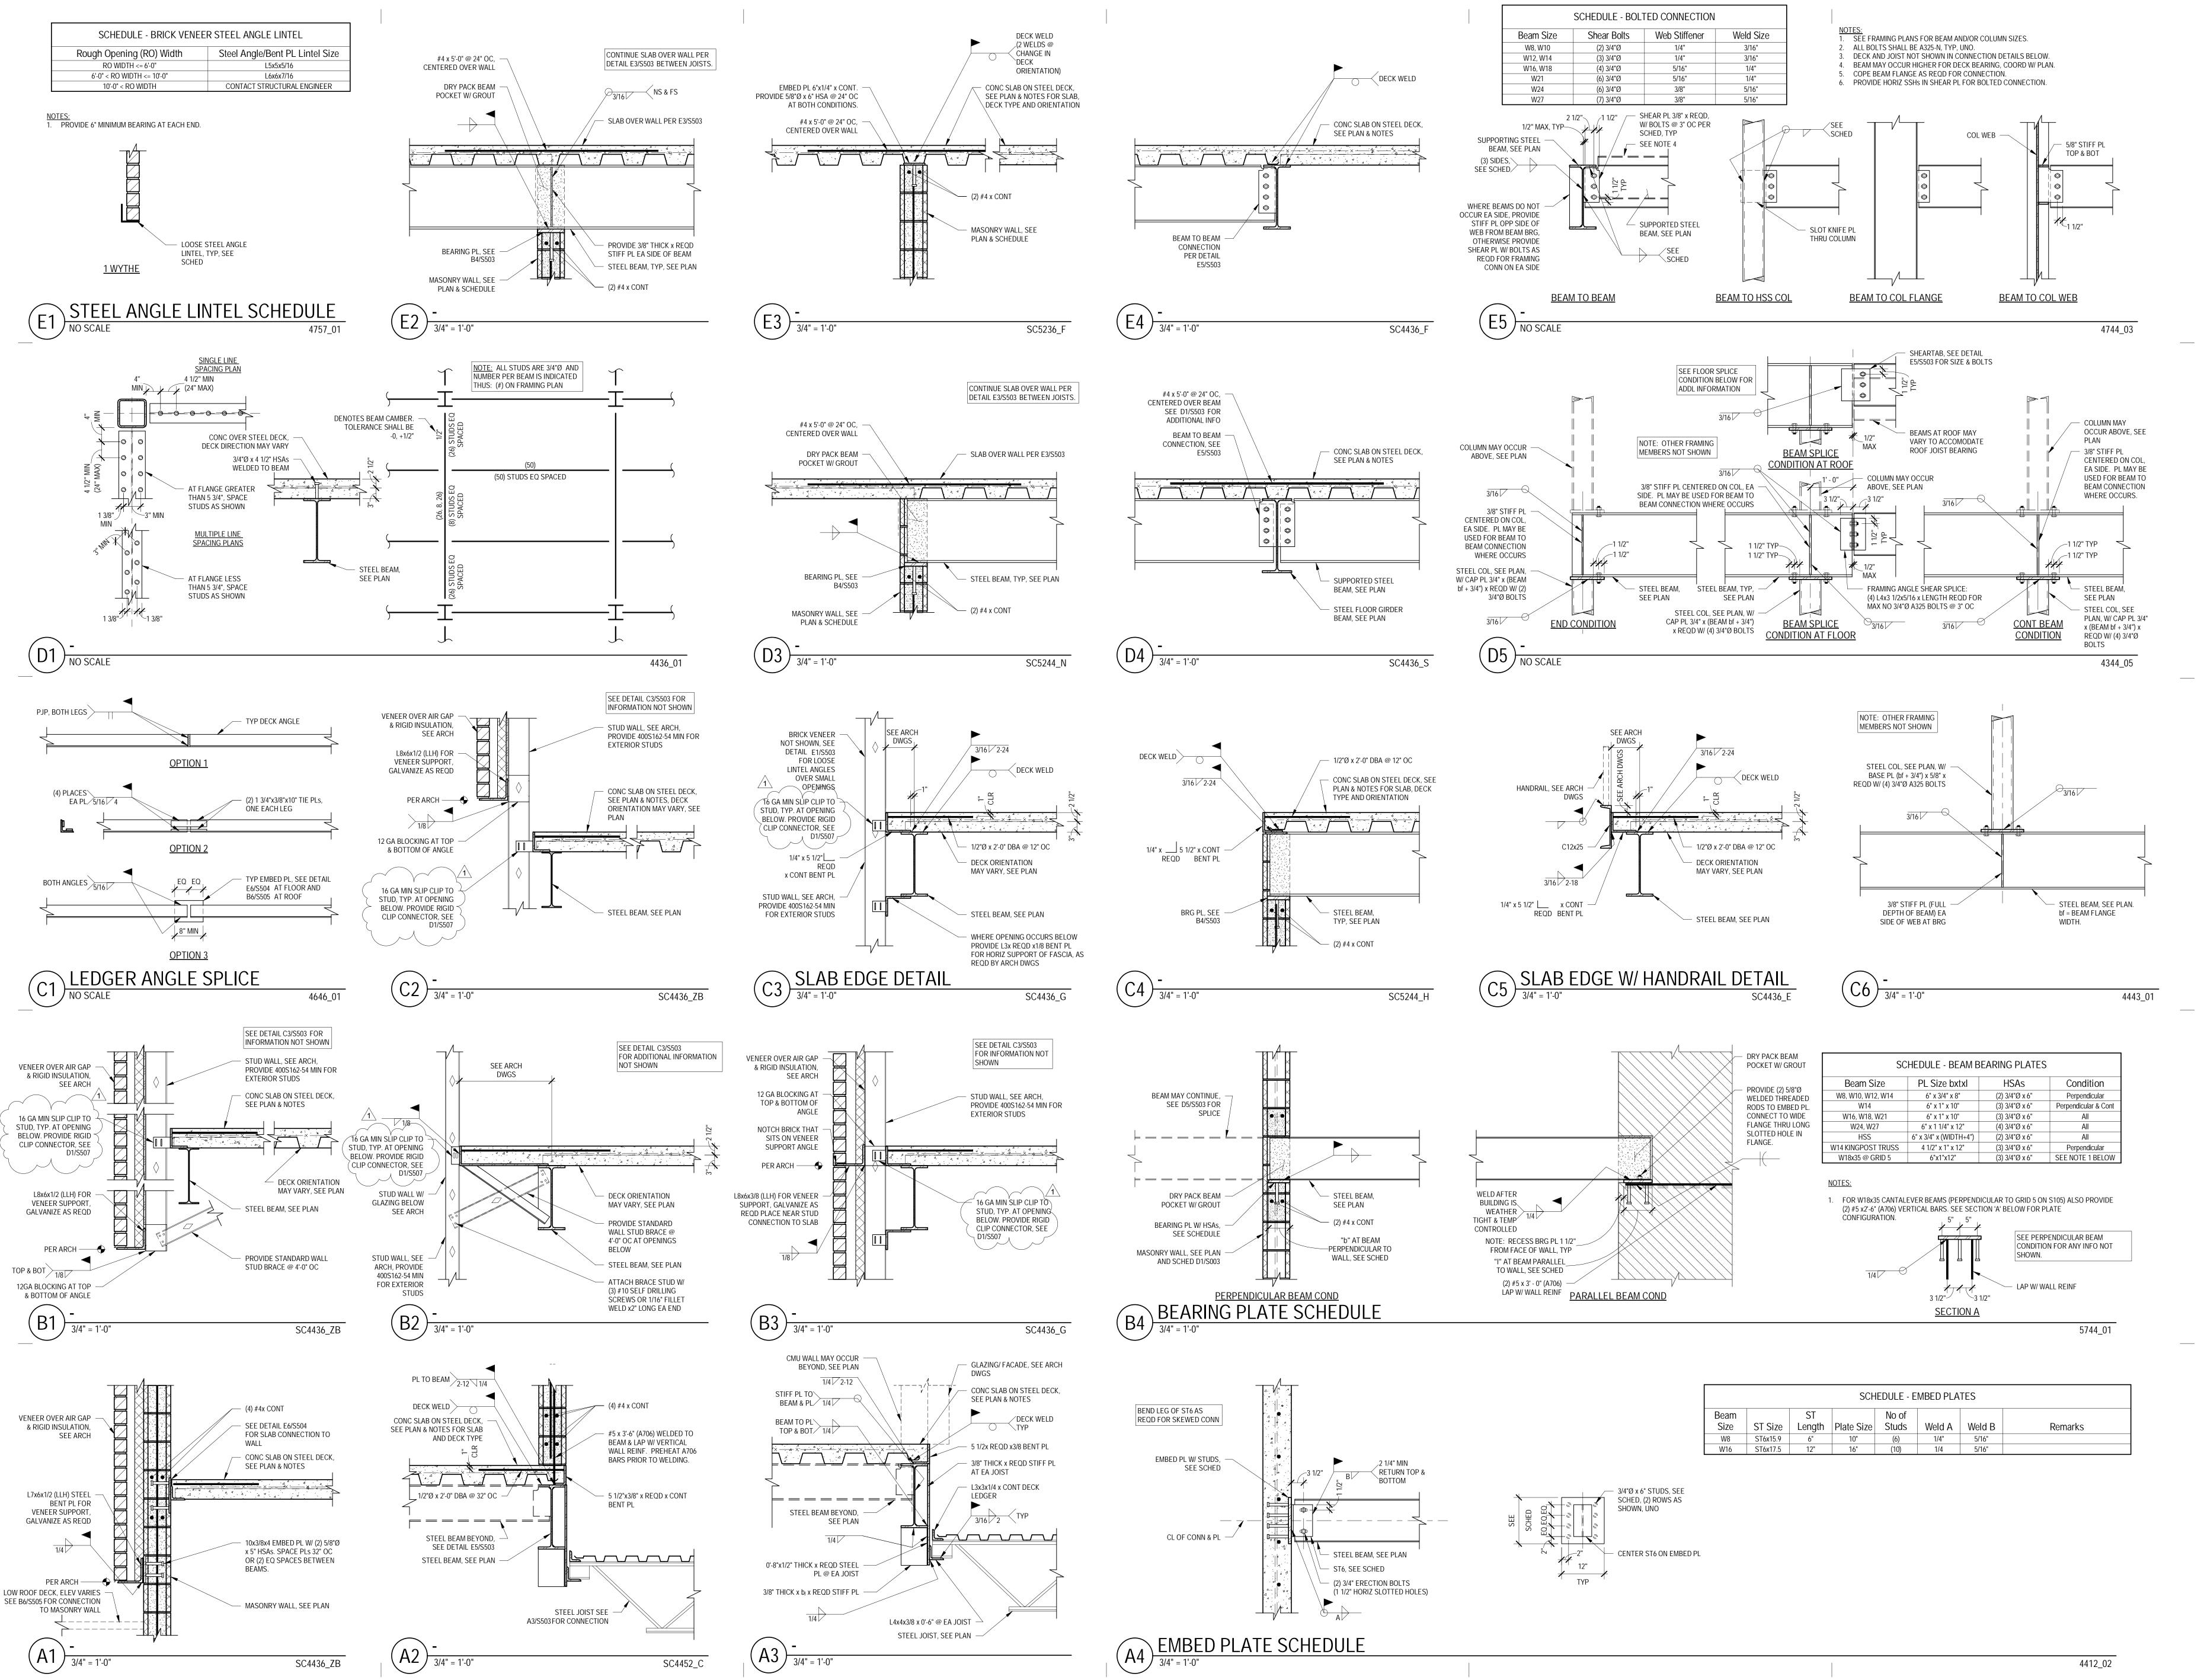

WENTWORTH



Ogden School District 1950 Monroe Blvd. Ogden, Utah 84401



Project For The Ogden School **District Board** of Education

T.O. Smith Elementary School Rebuild 3295 Gramercy Ave Ogden, Utah 84403

Project Phase **Bid Documents**

Revision Schedule No. Description Addendum 1

> Project Number 143.004


Project Issue Date

30 July 2020

Structural

Sheet Title

Sheet Number

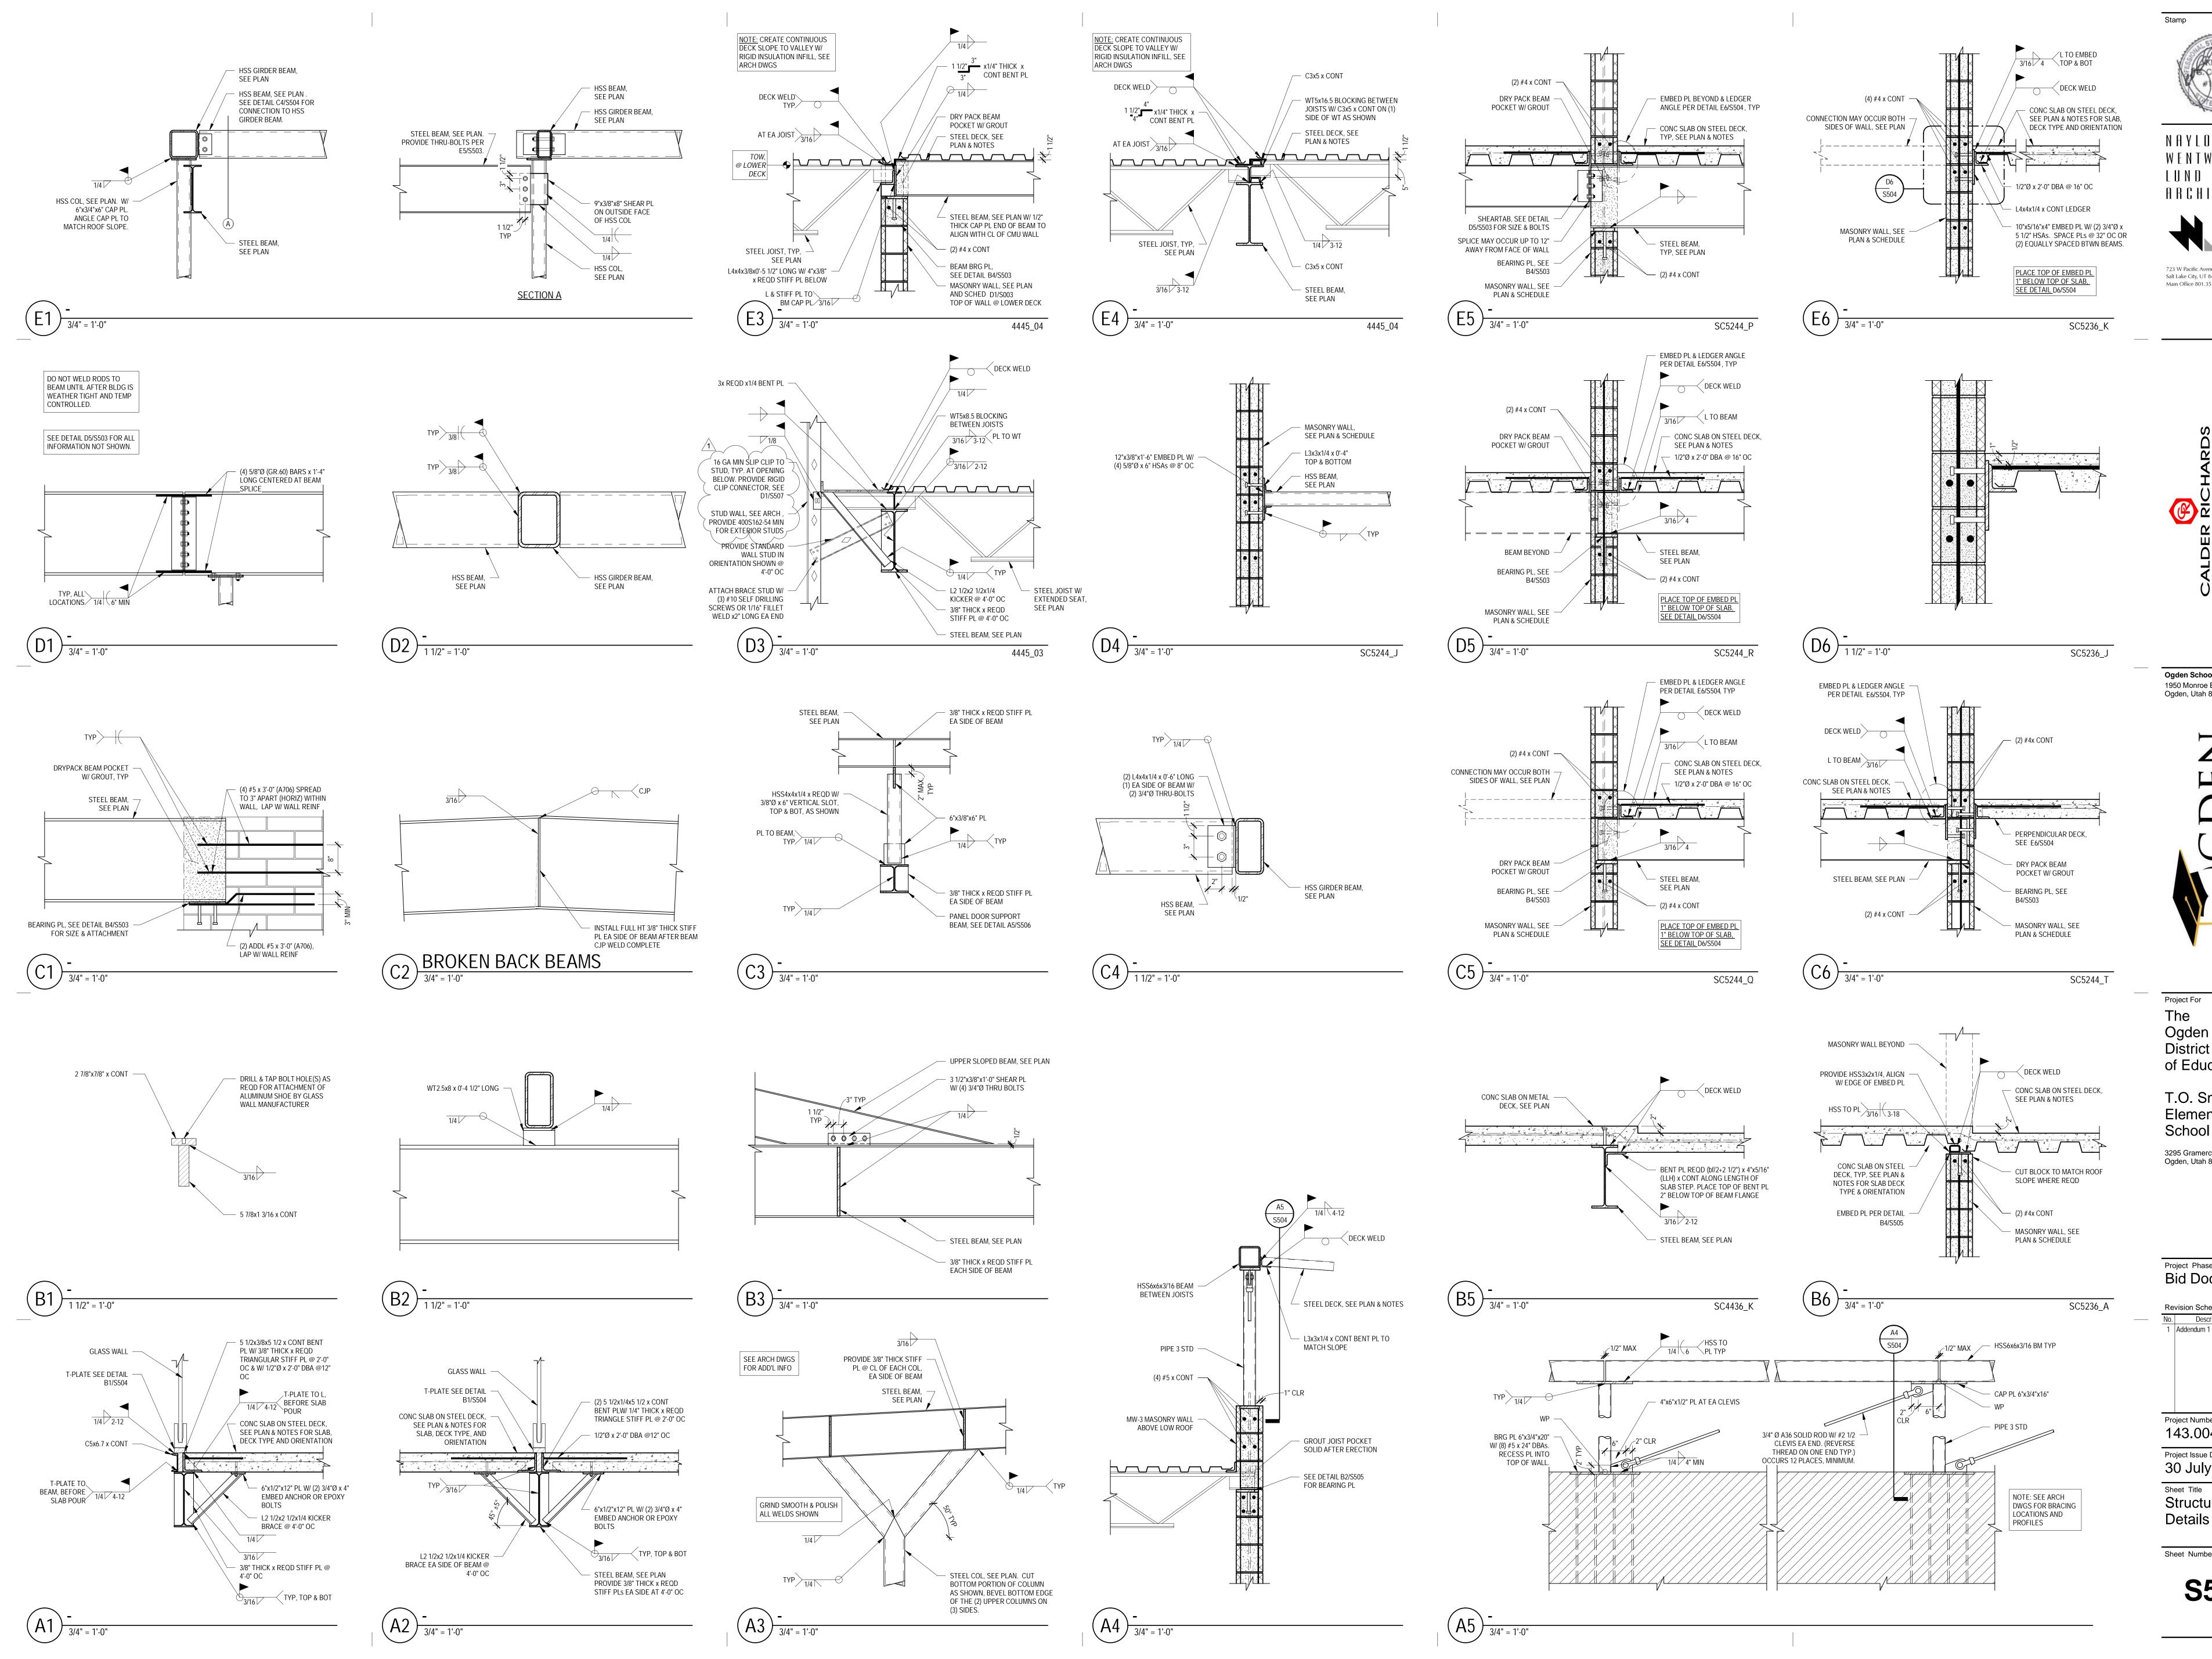

NAYLORWENTWORTH

723 W Pacific Avenue, Suite 101 Salt Lake City, UT 84104 Main Office 801.355.5959

Ogden School District Ogden, Utah 84401

Project For Ogden School District Board of Education

T.O. Smith Elementary School Rebuild 3295 Gramercy Ave Ogden, Utah 84403

Project Phase **Bid Documents**


Revision Schedule o. Description Addendum 1

Project Number 143.004

Project Issue Date 30 July 2020

Sheet Title Structural

Sheet Number

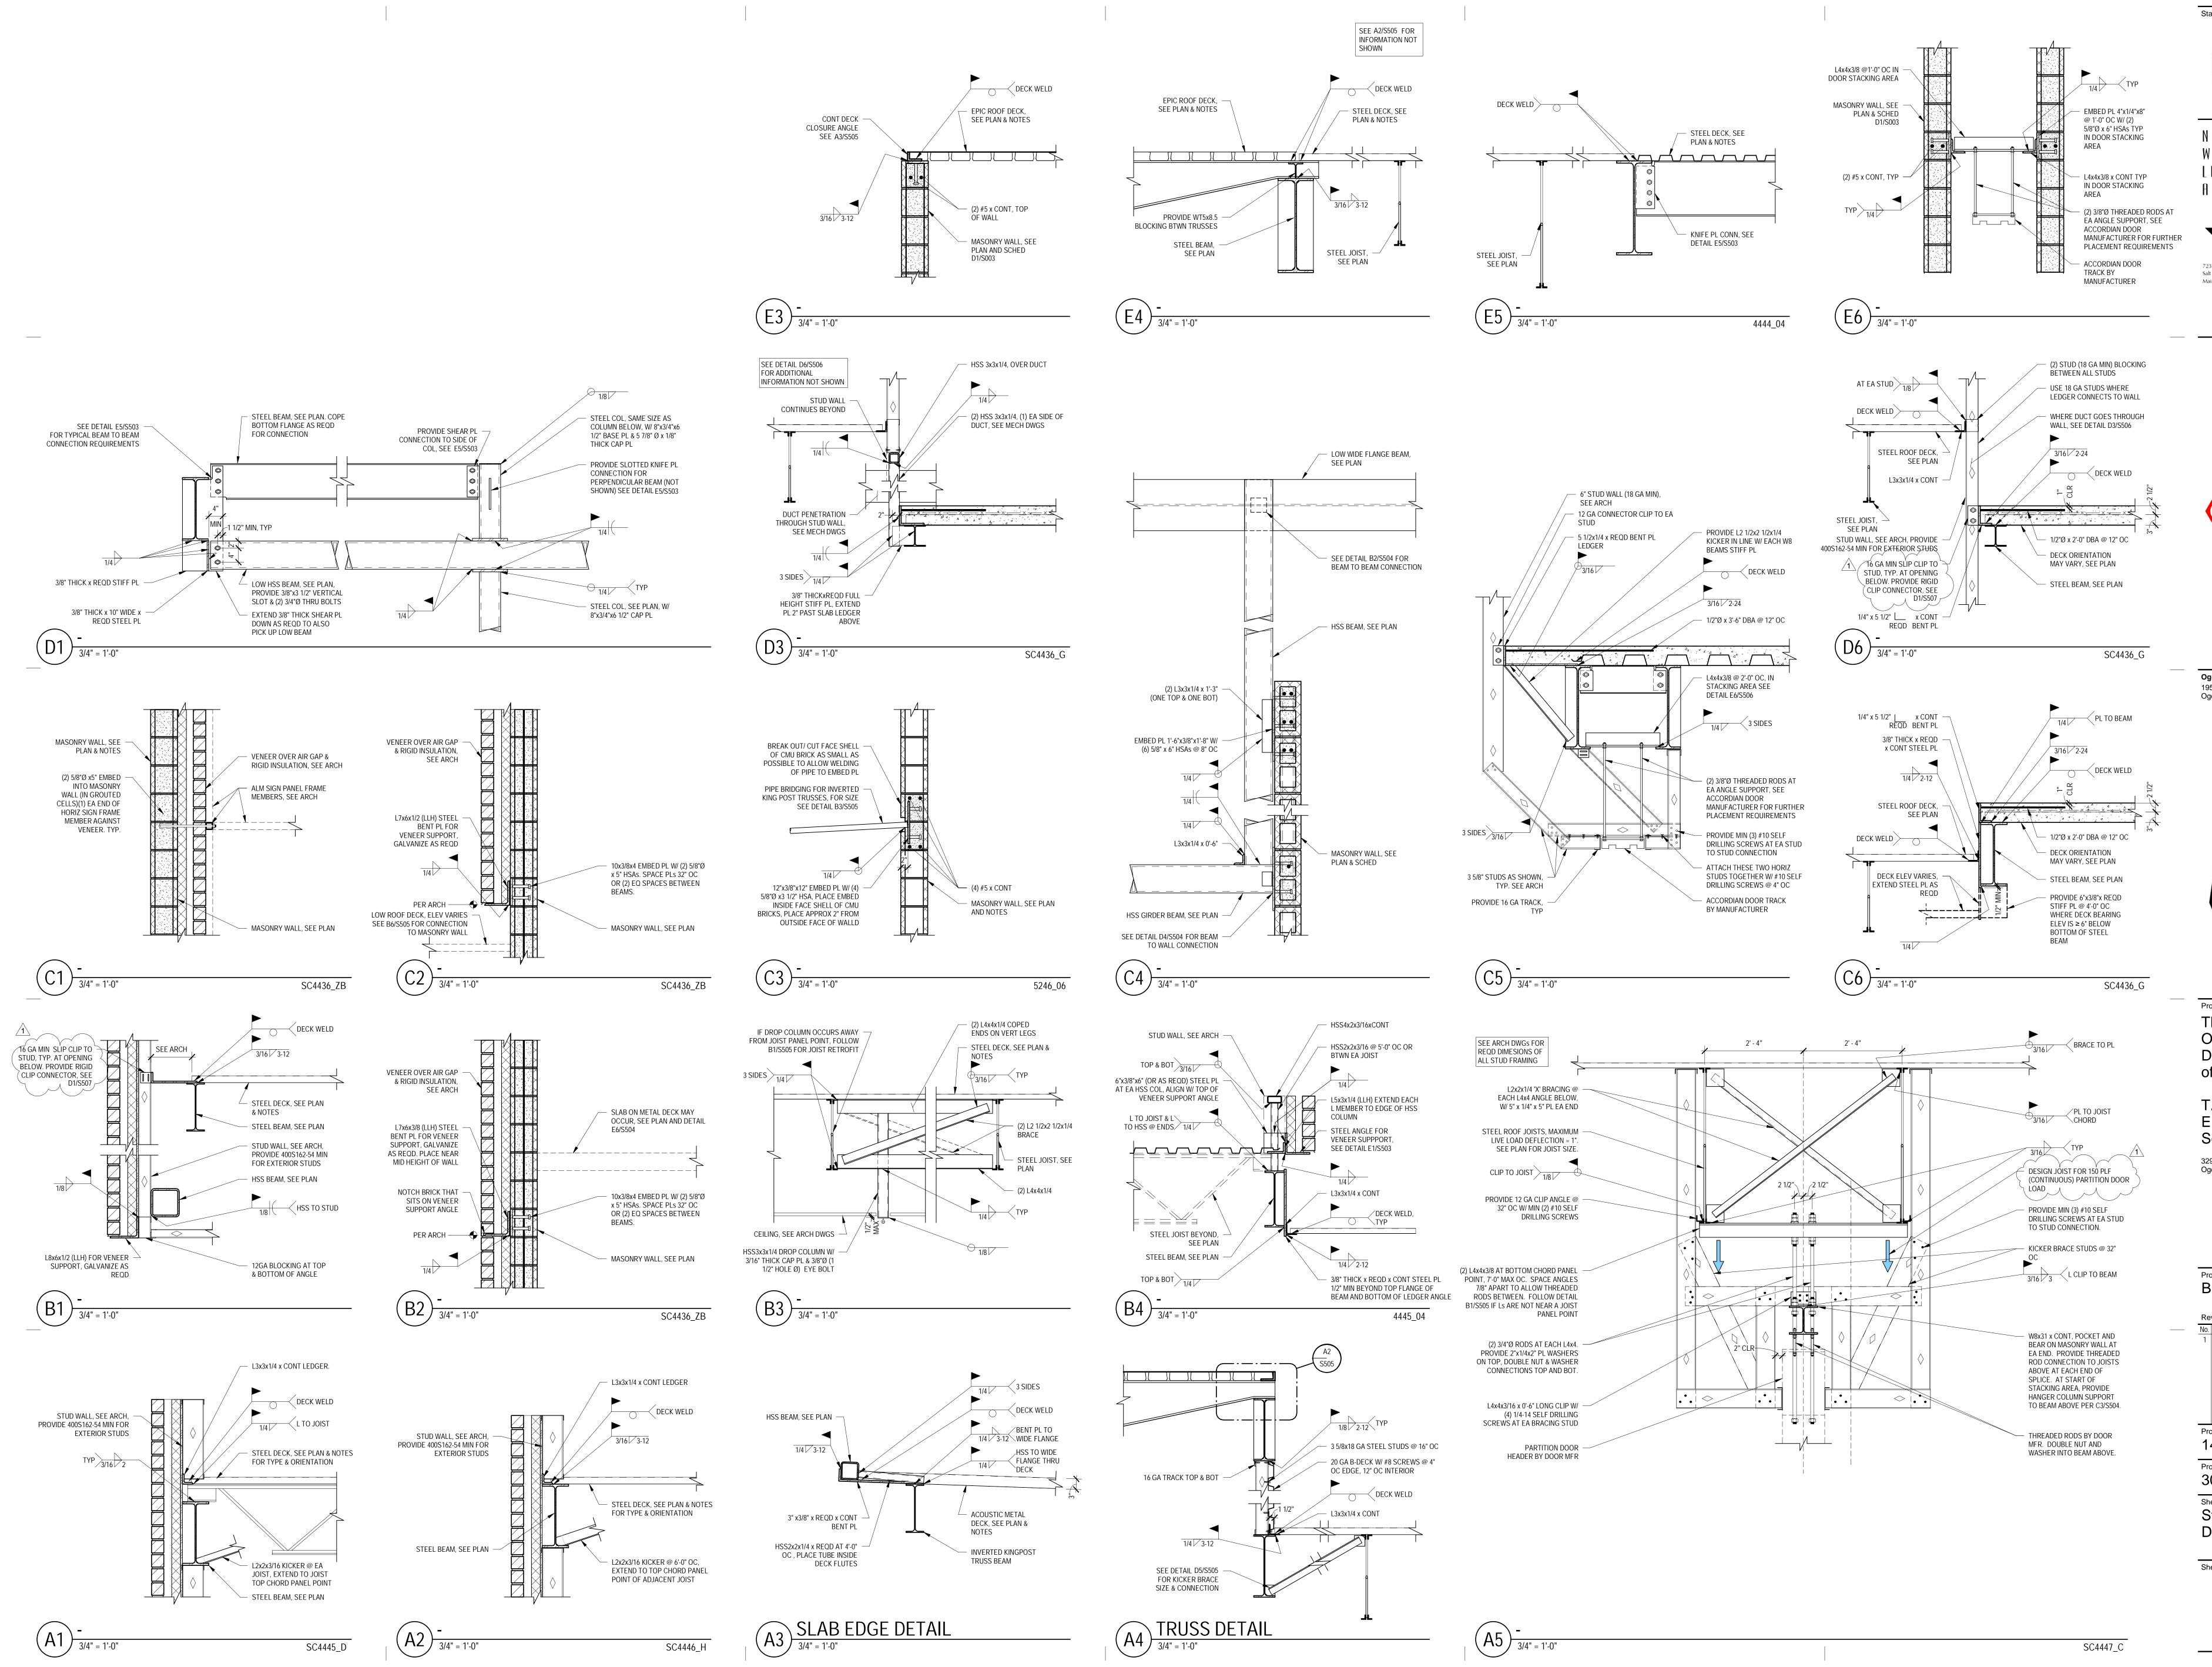

NAYLORWENTWORTH LUND



Main Office 801.355.5959

Ogden School District 1950 Monroe Blvd. Ogden, Utah 84401



Project For Ogden School **District Board** of Education

T.O. Smith Elementary School Rebuild 3295 Gramercy Ave Ogden, Utah 84403

Project Phase **Bid Documents**

Revision Schedule No. Description

> Project Number 143.004

Project Issue Date 30 July 2020

Sheet Title Structural **Details**

Sheet Number

ADDENDUM NO: 01

DATE: August 13, 2020

NWL PROJECT No: 143.004

PROJECT: T.O. Smith Elementary Rebuild

OWNER: Ogden School District

Ogden, Utah



THE ITEMS LISTED IN THIS **ADDENDUM NO: 01** WILL BECOME PART OF THE GENERAL CONTRACT AND WILL BE INCLUDED IN THE APPROPRIATE DRAWING OR SPECIFICATION SECTION AS NOTED UNDER EACH OF THE FOLLOWING ITEMS.

MECHANICAL

SPECIFICATIONS:

SECTION 220900

- 1. 220000-1.1.C PLUMBING FIXTURES Revise as follows:
 - A. WC-1 flush valve shall be Zurn sensor 1.6 ZER6200-CPM battery powered flush valve.
 - B. L-1 faucet shall be Moen 8886 2-handle ADA metering faucet.
 - C. L-2 faucet shall be Moen 8886 2-handle ADA metering faucet.
 - D. S-2 faucet shall be Moen 8792 minus spray.
- 2. 220700-4.31.1.E Revise as follows
 - A. Delete paragraph 'E'
- 3. 230900-4.1.9 PIPE JOINING Revise as follows:
 - A. All steel pipe under 2" in size shall be joined by screwed connections. Heating hot water and condenser (chilled) water piping shall be welded if pipe size is over 2".

Approved Manufacturers' Products:

The following manufacturers, trade names, and products are approved with the provision that they shall completely satisfy all and every requirement of the Drawings, Specifications, and all Addenda, and shall conform to the design, quality, and standards specified, established, and required for the complete and satisfactory installation and performance of the building and all its respective parts.

<u>PRODUCT</u> <u>MANUFACTURER</u>

Cooling Tower Filter PEP-Amiad
Fin Tube Radiation Rittling
Hot Water Unit Heaters Rittling

Circuit Setters Flow Design, Bell & Gossett

Test Plugs Trerice
Flow Venturis Flow Design
Strainers Titan
Check Valves Titan
Thermometers Miljoco
Pressure Gauges Miljoco

Expantion Joints/Loops Twin City Hose

Flexible Connectors Twin City Hose, Metraflex

Vibration Isolation Kinetics

Sesimic Services Seismic Restraint Systems (SRS)

Packaged Rooftop Units

Boiler Stacks

Metal Fan
Electric Unit Heaters

Berko

VAV Re-Heat Boxes Tuttle & Bailey Registers, Grilles, Diffusers Tuttle & Bailey

LouversAir Rite, United EnertechRoof HoodsAir Rite, Penn BarryRoof PenthouseWestern VentsSound TrapsPrice Industries

Flexible Duct JPL

Fire Dampers United Enertech
Fire/Smoke Dampers United Enertech

Manual Dampers United Enertech, Air Rite

HET Fittings Hercules

T.O. SMITH ELEMENTARY REBUILD OGDEN, UTAH

OGDEN SCHOOL DISTRICT OGDEN, UTAH

Domectic Water Heaters Laars, Lochinvar, PVI
Domestic Hot Water Storage Tanks Laars, Lochinvar, PVI

Domestic Expansion TanksElbiWater ClosetsSloanUrinalsSloanLavatorysSloan

Drinking Fountains
Oasis, Murdock
Flush Valves
American Standard
Shower Trim
American Standard, Acorn

Stainless Steel Sinks American Standard

Emergency FixturesAcornTempering ValvesAcornTrench DrainsWatts, Mifab

Ice Maker BoxLSPWasher BoxLSPFixture Stops & SuppliesLSPCleanoutsMifabTrap PrimersMifabTrap GuardsMifab

Toilet Seats American Standard

Fixture Carriers Mifab
Traps & Supplies McGuire

DRAWINGS:

Sheet M601:

- 1. Detail 6/M601:
 - a. Heating supply & return piping to individual boilers shall be 4". Reference detail 8/M606.

Sheet M605:

- 1. Detail 4/M605:
 - a. Reference sheet M404 Mechanical Room B227 for relief air connection to AHU-4.
 - b. Relief air connection shall be from back of AHU-4 to allow connection to louver L-4.

Sheet P201:

- 2. Mechanical Room A201:
 - a. Provide (2) FD-2 floor drains at location noted with note #13..
 - b. 3" waste shall be run from each floor drain to a combined 3" line that drops near grids H & 3. See enlarged waste/vent plan P401 note #25 for continuation.

END OF ADDENDUM 01



ELECTRICAL ADDENDUM #1

To:Justin Nye, AIAFrom:Scott KingeryCompany:NWL ArchitectsPhone:801.355.5959

Date: August 13, 2020

Project TO Smith Elementary – Rebuild Project #: 2019-179

The following are addendum changes to the electrical drawings:

Bidding Questions:

Can Cutler Hammer be approved to bid and supply their electrical gear across the board? They are approved for panels but not magnetic starters. Please review and approve them for their typical full gear package.

Yes, Cutler Hammer is approved to bid the complete Gear Package.

Section 26 3200 alternate number 2 lists Creative Energies, 405 watt module LG405N2W-V5 for the solar alternate. Is the intention of alternate #2 to use the LG 405 watt module or is it to use the contractor Creative Energies as the sole sourced installer?

Alternate #2 is for the Creative Energies PV Modules in lieu of Sunpower Helix. See Alternate Descriptions and Requirements in the Architectural Specifications. Creative Energies is an approved installer, See Specification 26 3200 Section 2.2(A)(1).

SPECIFICATIONS:

<u>Section 27 1100 – Communication Room Equipment Fittings, 27 1300 - Communications Backbone Cabling, 27 1500 - Communications Horizontal Cabling</u>

1. Add ARCO Electric to the approved supplier / installers.

PRODUCT APPROVALS:

Pending compliance to all specified requirements, the following manufacturers are approved to bid this project in addition to those shown on the electrical drawings or the electrical specifications. Approval does not relieve the contractor of fulfilling all specified requirements regardless of what is contained in the prior approval packages submitted by various lighting agencies to the electrical engineer. Light fixtures specified on drawings shall be considered basis-of-design products; all light fixtures approved by addendum shall be equivalent in every respect to those currently specified on the drawings. Non-compliance to these requirements may later result in disapproval in which case the contractor shall be required to provide specified products at no additional cost to the Owner:

Lighting Fixtures:

<u>Type</u>	<u>Manufacturers</u>				
A13	Lithonia	Visionaire	Beacon	McGraw-Edison	Deco
A13A	Lithonia	Visionaire	Beacon	McGraw-Edison	Deco
A15	Lithonia	Visionaire	Beacon	McGraw-Edison	Deco
AW1	Lithonia	Williams	Hubbell	Lumark	Crystal
CR1	Lithonia	Williams	Columbia	Metalux	Alphalite
CR2	Lithonia	Williams	Columbia	Metalux	Alphalite



ADDENDUM

CR3	Lithonia	Williams	Columbia	Metalux	LA Lighting
DL1	Lithonia	Williams	Liton	Halo	Peachtree
DL2	Lithonia	Williams	Liton	Halo	Peachtree
DLS	Lithonia	Williams	Liton	Halo	Peachtree
F1	Lithonia	Williams	Columbia	Metalux	LA Lighting
FP	Lithonia	Gardco	Hubbell	Lumark	
GA1	Lithonia	Williams	Columbia	Metalux	LA Lighting
GA2	Lithonia	Williams	Columbia	Metalux	LA Lighting
GA3	Lithonia	Williams	Columbia	Metalux	LA Lighting
GA4	Lithonia	Williams	Columbia	Metalux	LA Lighting
GA21	Lithonia	Williams	Columbia	Metalux	LA Lighting
GID1	Lithonia	Williams	Columbia	Metalux	Alphalite
GID2	Lithonia	Williams	Columbia	Metalux	Alphalite
GID3	Lithonia	Williams	Columbia	Metalux	Alphalite
GID4	Lithonia	Williams	Columbia	Metalux	Alphalite
HB1	Lithonia	Williams	Columbia	Metalux	LA Lighting
LL1	Kelvix	Omnilight	Acolyte	Q-Tran	Twice Bright
P1	OCL – Contracto	or Allowance \$445	.00 (each)		
P2	Spectrum – Con	tractor Allowance	\$390.00 (each)		
PD1	Mark	Pinnacle	Litecontrol	Neo-Ray	Lumato
PD2	Mark	Pinnacle	Litecontrol	Neo-Ray	Lumato
RL1	Mark	Pinnacle	Litecontrol	Neo-Ray	Day-O-Lite
RL2	Mark	Pinnacle	Litecontrol	Neo-Ray	Day-O-Lite
RL3	Mark	Pinnacle	Litecontrol	Neo-Ray	Day-O-Lite
ST1	ETC	Vari Lite	Altman	Chauvet	
SW1	Lithonia	Williams	Columbia	Metalux	Alphalite
SW2	Lithonia	Williams	Columbia	Metalux	Alphalite
SW3	Lithonia	Williams	Columbia	Metalux	Alphalite
VL	Lithonia	Stonco	Hubbell	Lumark	Duraguard
X1	Lithonia	Emergensee	Duallite	Evenlite	Exitronix
X2	Lithonia	Emergensee	Duallite	Evenlite	Exitronix
X3	Lithonia	Emergensee	Fortezza	Evenlite	Exitronix

Approved Lighting Controls – nLight (basis of design), Wattstopper and Lutron (Wired Only)

DRAWINGS:

Sheet EL101 - Area A1 - Lighting Plan

- Add additional switching for Collaboration and Corridor.
 See attached sheet.

Sheet EL102 - Area B1 - Lighting Plan

- 1. Add additional switching for Collaboration and Corridor.
- 2. See attached sheet.

Sheet EL201 - Area A2 - Lighting Plan

- 1. Add additional switching for Collaboration and Corridor.
- 2. See attached sheet.



Sheet EL202 - Area B2 - Lighting Plan

- 1. Add additional switching for Collaboration and Corridor.
- 2. See attached sheet.

Sheet EL601 - Light Fixture Schedule

1. Fixture F1 – Change lumen output from 2,000 to 3,000.

Sheet EP101 - Area A1 - Power Plan

- 1. Add an additional data location in Counselor A164.
- 2. See attached sheet.

Sheet EP102 - Area B1 - Power Plan

- 1. Add an additional data location in Faculty Lounger B102.
- 2. See attached sheet.

Sheet EY101 - Area A1 - Systems Plan

- 1. Remove Door Position Switches from the Access Controlled Doors.
- 2. Add Door Controls to Office / Conf A150.
- 3. Update door controls Reception A157.
- 4. See attached sheet.

Sheet EY102 - Area B1 - Systems Plan

- 1. Remove Door Position Switches from the Access Controlled Doors.
- 2. See attached sheet.


Sheet EY202 - Area B2 - Systems Plan

- 1. Remove Door Position Switches from the Access Controlled Doors.
- 2. Update door controls Flex Learning Studio B202.
- 3. See attached sheet.

Sheet EY703 - Area A1 - Systems Plan

- 1. Update Access Control Door Matrix.
- See attached sheet.

End of Electrical Addendum #1

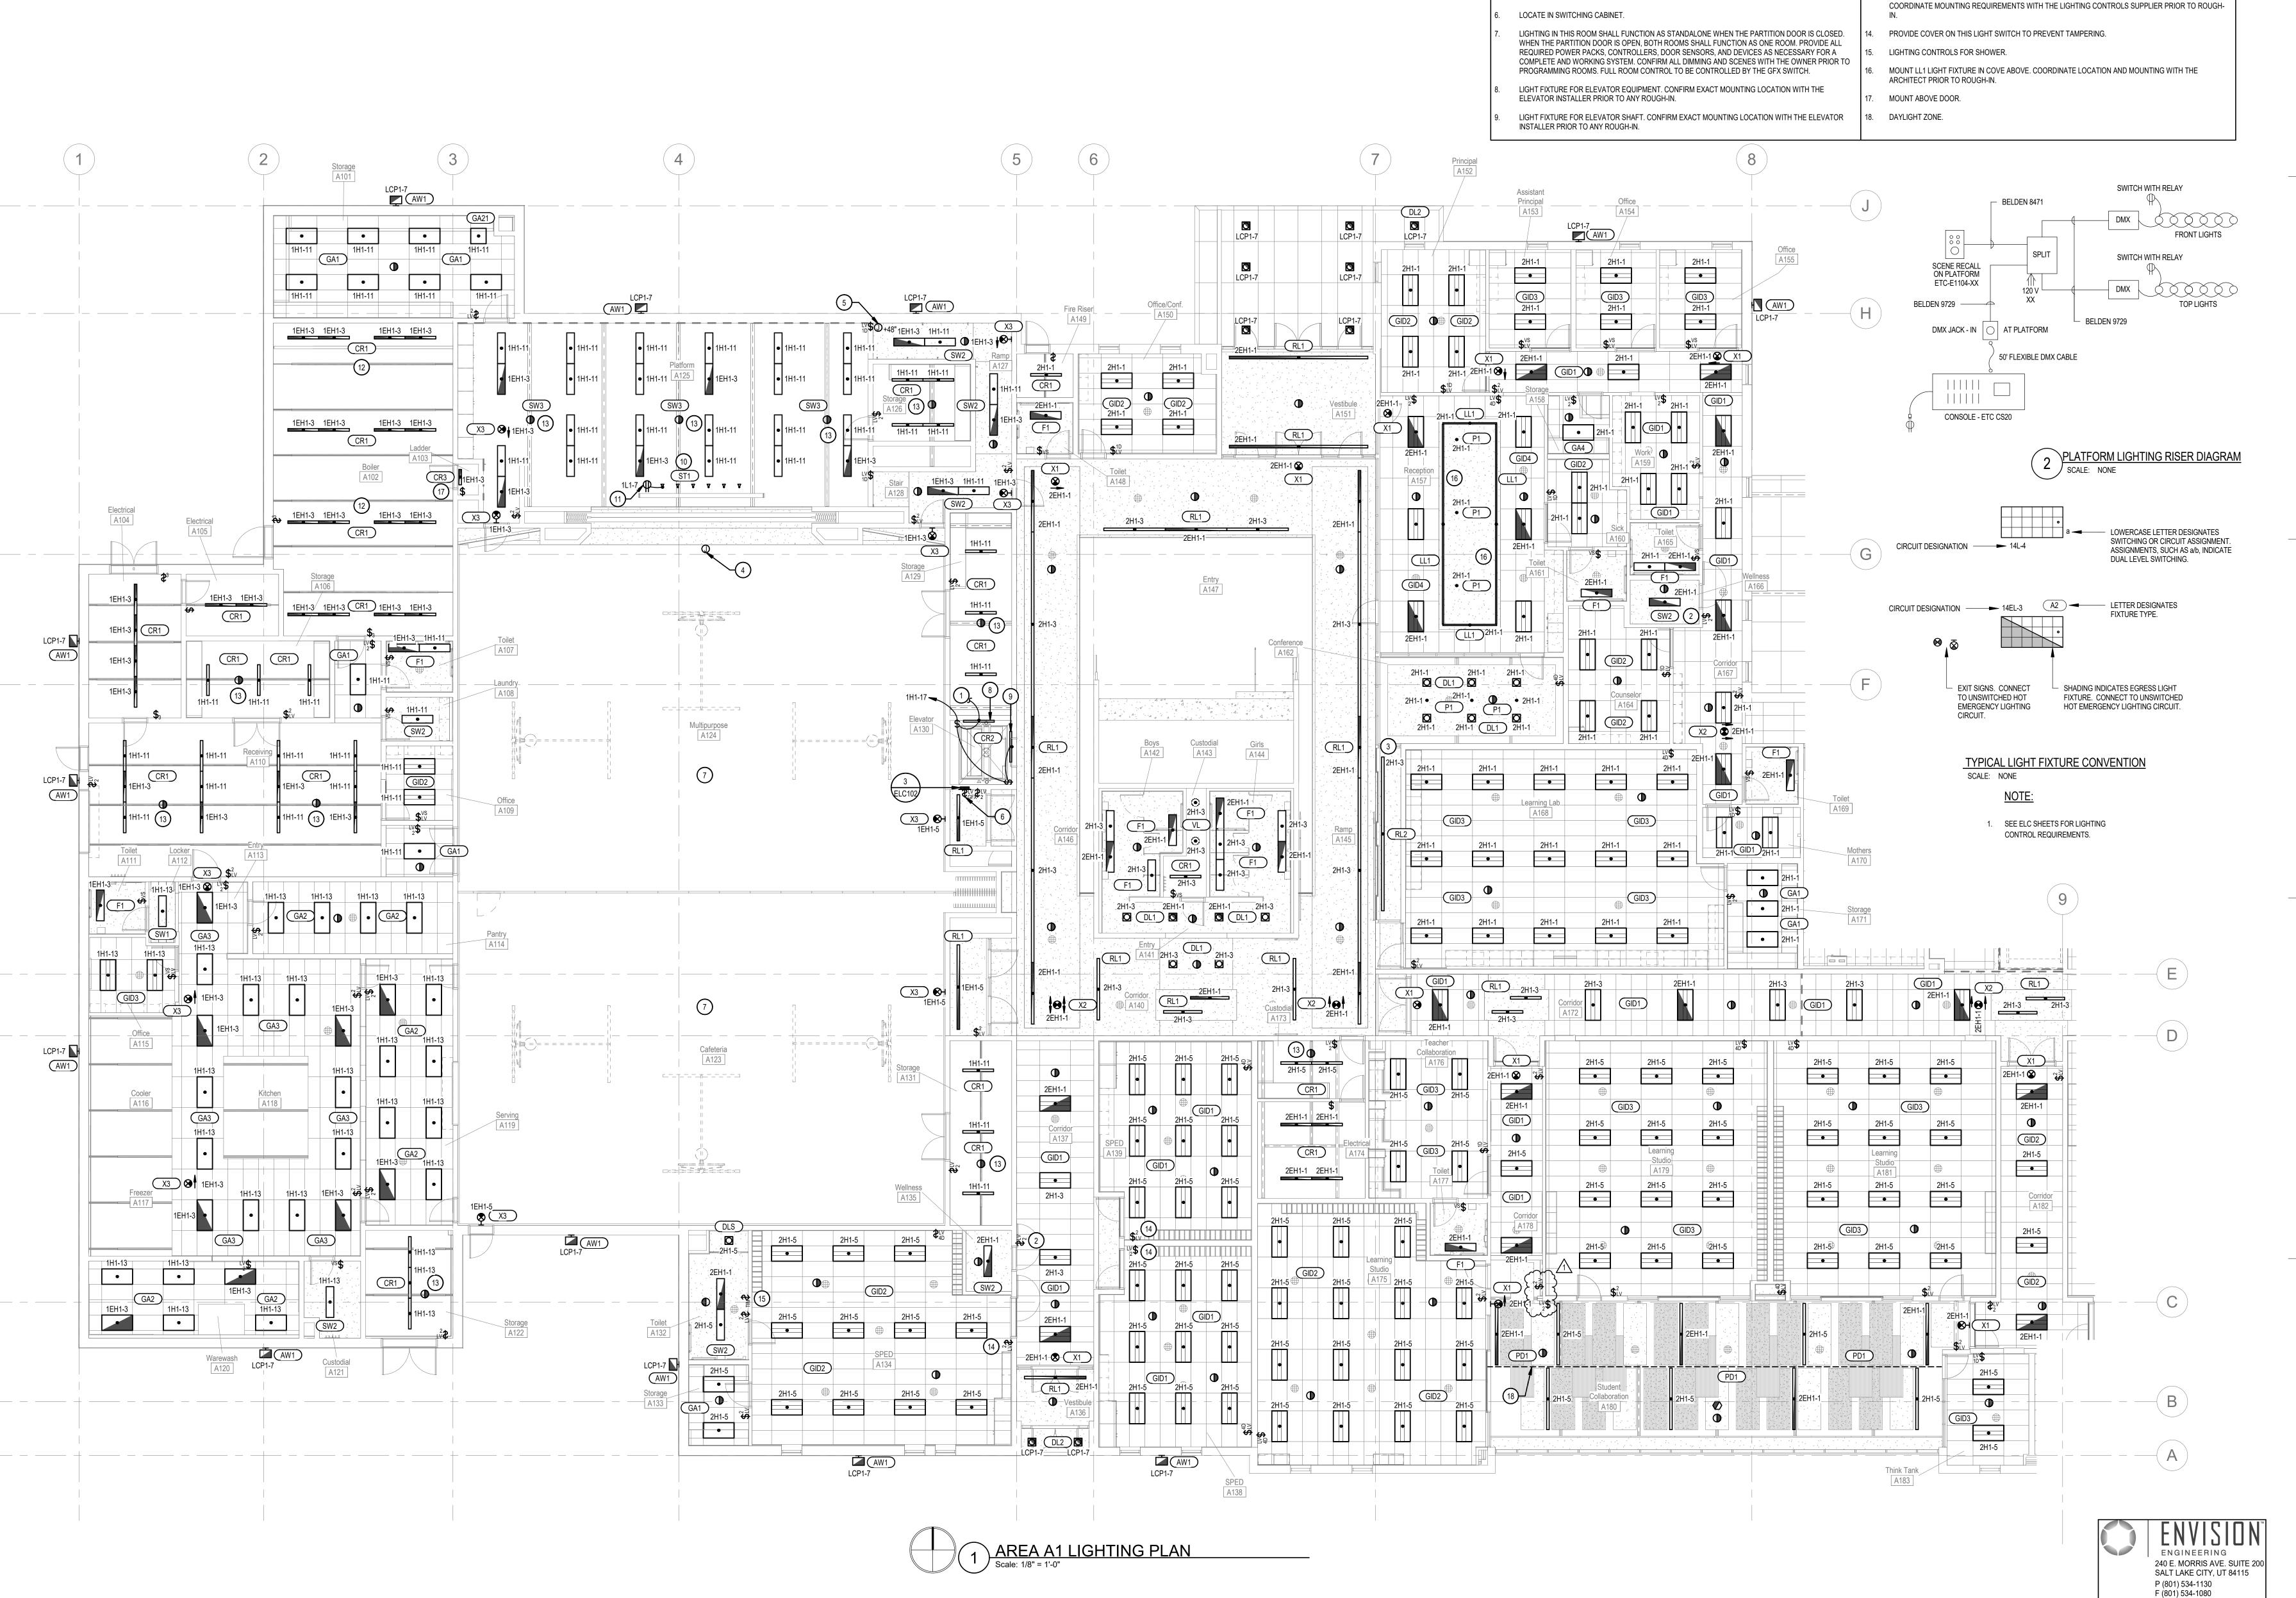

LIGHTING GENERAL NOTES:

ENTRANCES.

REFER TO ELC SHEETS FOR TYPICAL CONTROL WIRING DIAGRAMS. PROVIDE COMPLETE SYSTEM WITH

LOCATE POWER PACKS AND ROOM CONTROLLERS ABOVE ACCESSIBLE CEILING NEAR ROOM

CONFIRM ALL LOCATIONS OF LIGHT FIXTURES WITH ARCHITECT PRIOR TO INSTALLATION.

ALL REQUIRED CONDUIT, WIRING, SWITCHES, SENSORS, POWER PACK, ETC.

KEYED NOTES: #

UP TO LIGHT ABOVE.

LIGHT SWITCH FOR WELLNESS ROOM.

ADDITIONAL INFORMATION.

DISPLAY CASE LIGHTS TO SWITCH WITH CORRIDOR LIGHTS.

RISER 2/EL101 FOR ADDITIONAL INFORMATION.

DMX JACK-IN. MOUNT NEXT TO POWER AND DATA. SEE EP101 FOR POWER AND DATA LOCATION. SEE

SCENE RECALL STATION. CONFIRM EXACT MOUNTING LOCATION WITH OWNER. SEE RISER 2/EL101 FOR

JEFFREY R. OWEN
No.177411

N A Y L O R W E N T W O R T H L U N D

PROVIDE RIGID PIPE CLAMP MOUNT FOR STAGE LIGHT FIXTURES. SEE ARCHITECTURAL DRAWINGS FOR PIPE REQUIREMENTS. COORDINATE MOUNTING REQUIREMENTS WITH FIXTURE SUPPLIER. SPACE LIGHT

FIXTURES PER SUPPLIER RECOMMENDATIONS. IF INSTALLED AS SHOWN, THE CONTRACTOR WILL

ADJUST LIGHTS IN THIS AREA FOR MECHANICAL EQUIPMENT, PIPING AND DUCTWORK. ADJUST

MOUNT OCCUPANCY SENSOR ON BOTTOM OF TRUSS SO SENSOR HAS A CLEAR VIEW OF THE ROOM.

LIGHTING TO ADEQUATELY LIGHT THE ROOM AND SPACES AROUND THE EQUIPMENT.

RELOCATE AT NO ADDITIONAL COST TO THE OWNER.

MOUNT RECEPTACLE NEXT TO STAGE LIGHTS. SEE RISER 2/EL101.



Salt Lake City, UT 84104

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Project For
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Project Phase
Bid Documents

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1 Addendum #1 08/13/20

Project Number 143.004

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Sheet Title
AREA A1 LIGHTING
PLAN

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EL101

LIGHTING GENERAL NOTES:

REFER TO ELC SHEETS FOR TYPICAL CONTROL WIRING DIAGRAMS. PROVIDE COMPLETE SYSTEM WITH ALL REQUIRED CONDUIT, WIRING, SWITCHES, SENSORS, POWER PACK, ETC. LOCATE POWER PACKS AND ROOM CONTROLLERS ABOVE ACCESSIBLE CEILING NEAR ROOM

CONFIRM ALL LOCATIONS OF LIGHT FIXTURES WITH ARCHITECT PRIOR TO INSTALLATION.

KEYED NOTES:

MOUNT ABOVE DOOR. DAYLIGHT ZONE.

NAYLOR WENTWORTH LUND



Main Office 801.355.5959

Ogden School District

Ogden School District Board of Education

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Sheet Title
AREA B1 -LIGHTING PLAN

Sheet Number


EL102

TYPICAL LIGHT FIXTURE CONVENTION SCALE: NONE

- EXIT SIGNS. CONNECT SHADING INDICATES EGRESS LIGHT

TO UNSWITCHED HOT EMERGENCY LIGHTING FIXTURE. CONNECT TO UNSWITCHED

HOT EMERGENCY LIGHTING CIRCUIT.

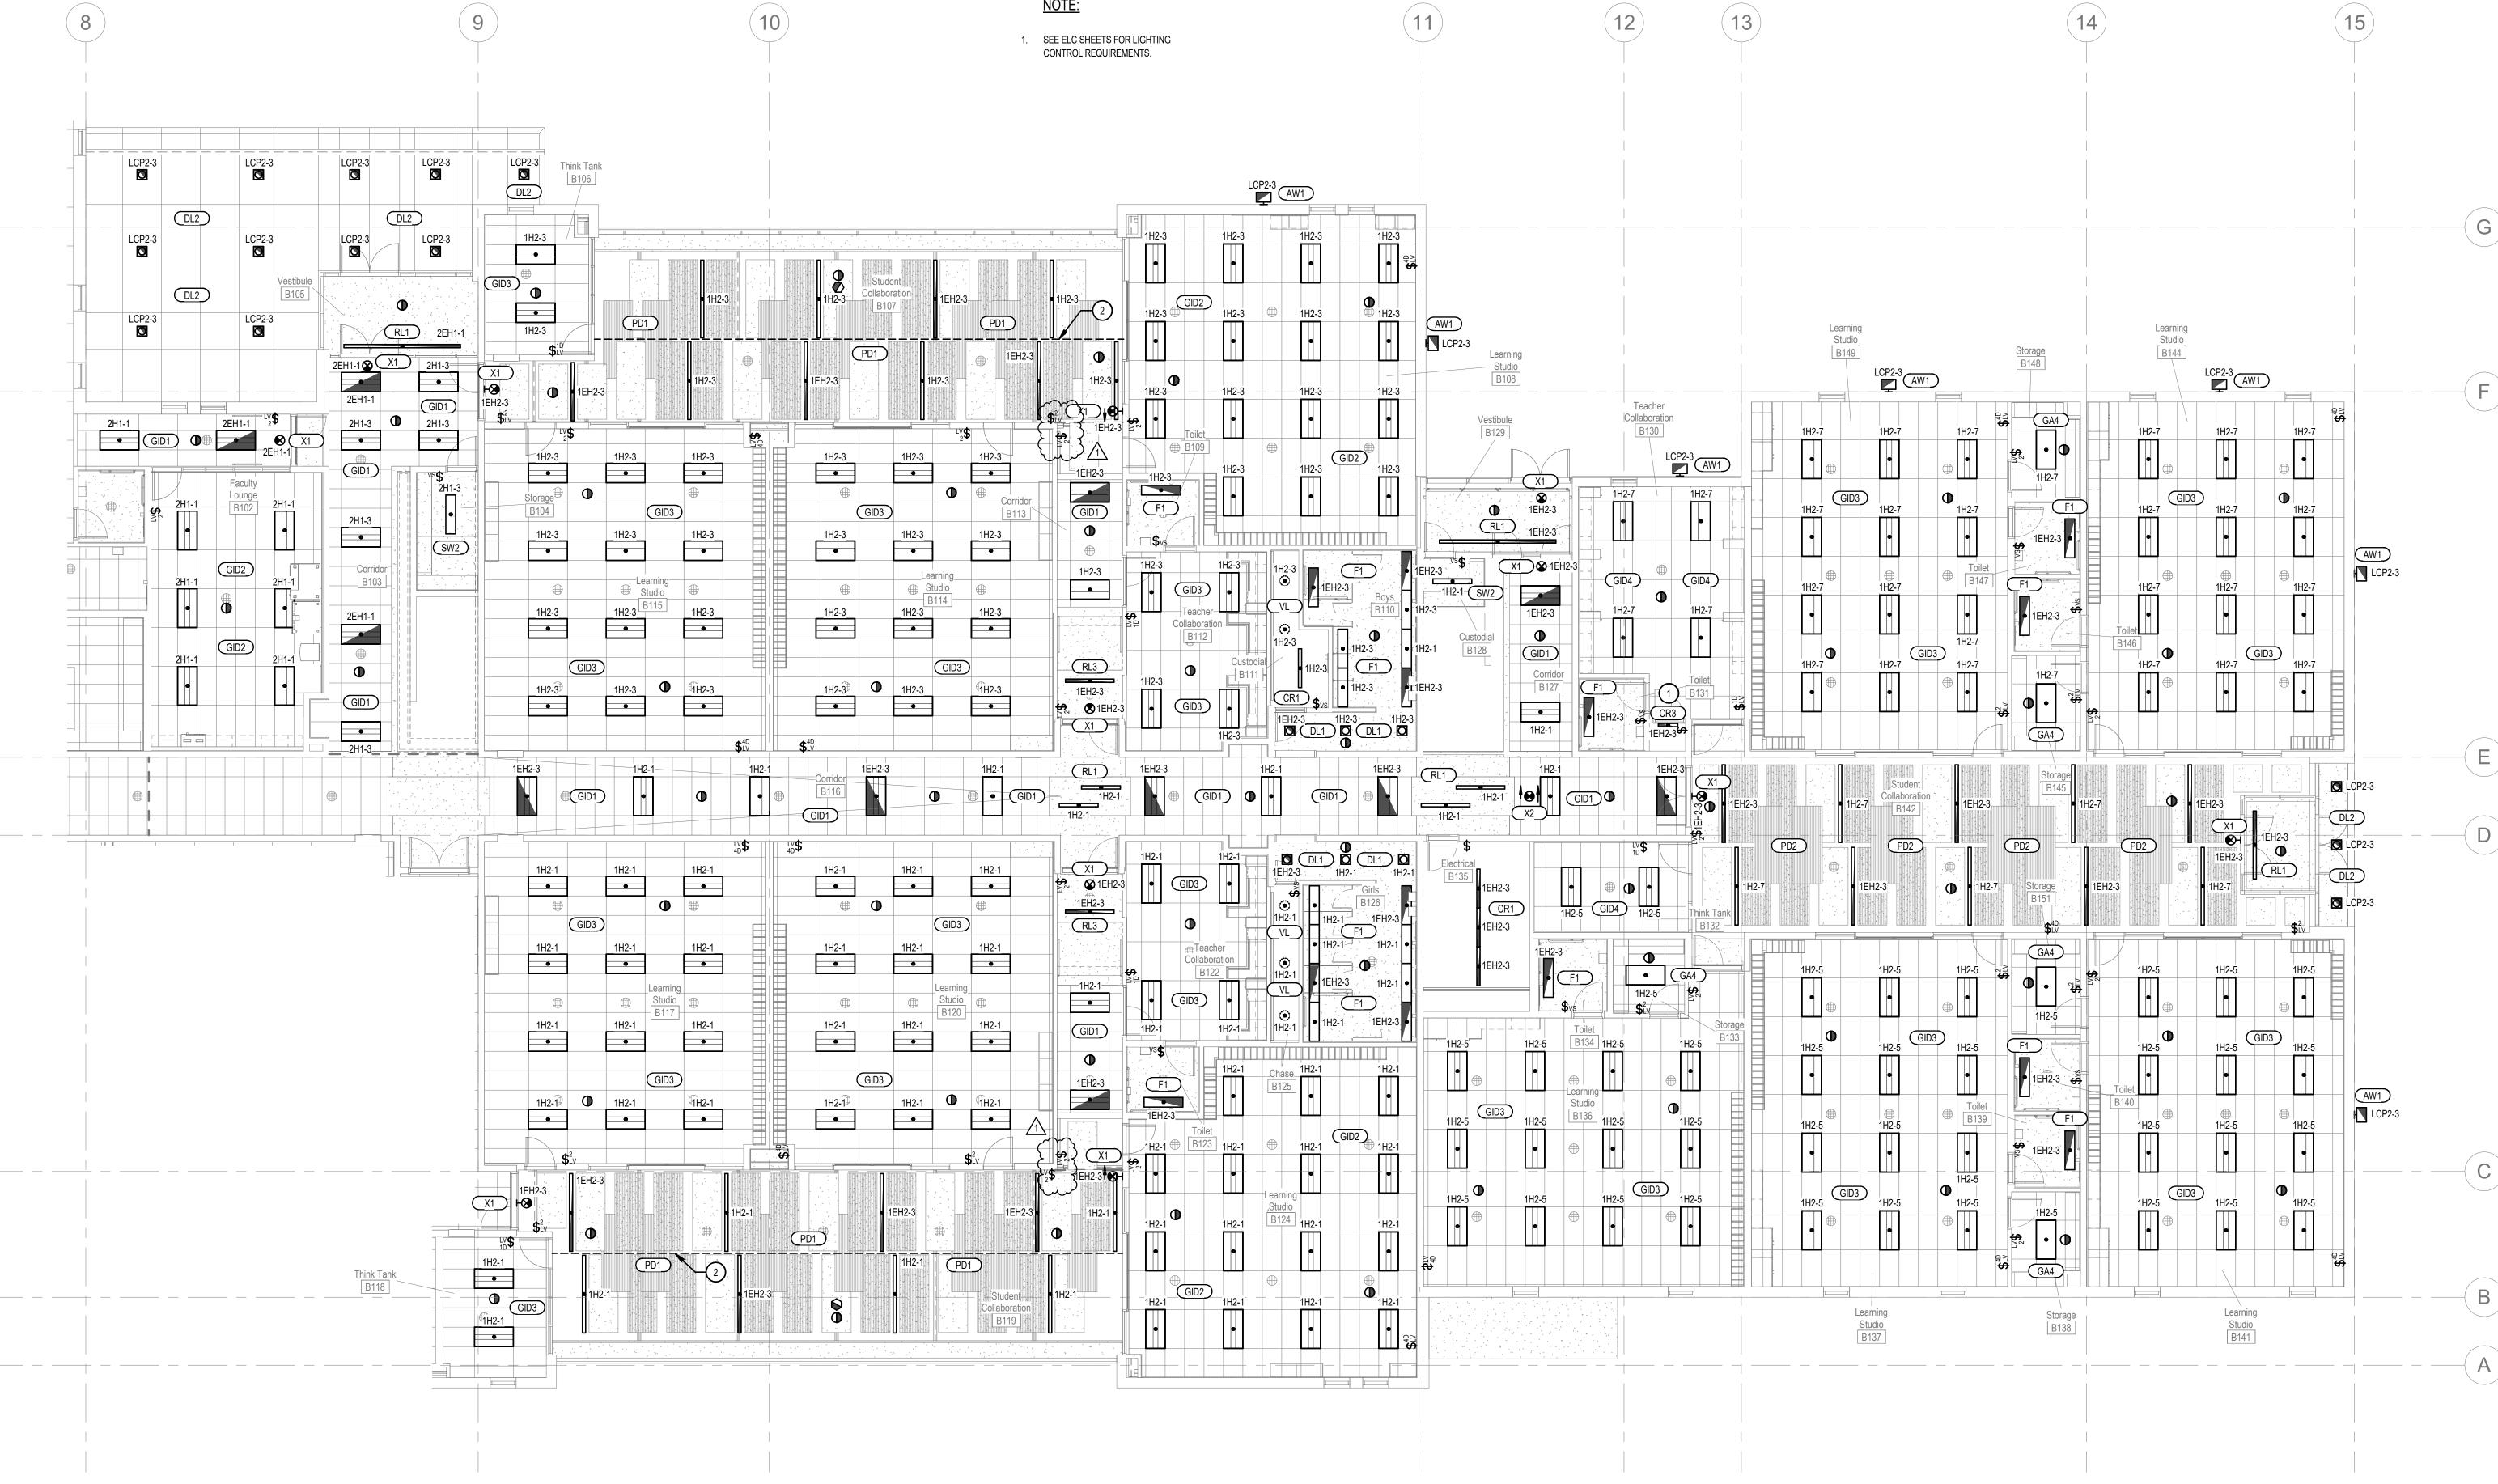

AREA B1 - LIGHTING PLAN

Scale: 1/8" = 1'-0"

AREA A2 - LIGHTING PLAN

Scale: 1/8" = 1'-0"

REFER TO ELC SHEETS FOR TYPICAL CONTROL WIRING DIAGRAMS. PROVIDE COMPLETE SYSTEM WITH ALL REQUIRED CONDUIT, WIRING, SWITCHES, SENSORS, POWER PACK, ETC.

LOCATE POWER PACKS AND ROOM CONTROLLERS ABOVE ACCESSIBLE CEILING NEAR ROOM

CONFIRM ALL LOCATIONS OF LIGHT FIXTURES WITH ARCHITECT PRIOR TO INSTALLATION.

KEYED NOTES: #

PROVIDE WIRE GUARD ON THIS DEVICE.

DOWN TO LIGHT BELOW.

LIGHT SWITCH FOR WELLNESS ROOM.

LIGHT FIXTURE FOR ELEVATOR SHAFT. CONFIRM EXACT MOUNTING LOCATION WITH THE ELEVATOR INSTALLER PRIOR TO ANY ROUGH-IN.

PROVIDE RIGID PIPE CLAMP MOUNT FOR STAGE LIGHT FIXTURES. COORDINATE WITH FIXTURE SUPPLIER. SPACE LIGHT FIXTURES PER SUPPLIER RECOMMENDATIONS. IF INSTALLED AS SHOWN THE CONTRACTOR WILL RELOCATE AT NO ADDITIONAL COST TO THE OWNER.

MOUNT RECEPTACLE NEXT TO STAGE LIGHTS. SEE RISER 2/EL101.

ADJUST LIGHTS IN THIS AREA FOR MECHANICAL EQUIPMENT, PIPING AND DUCTWORK. ADJUST LIGHTING TO ADEQUATELY LIGHT THE ROOM AND SPACES AROUND THE EQUIPMENT.

MOUNT OCCUPANCY SENSOR ON BOTTOM OF TRUSS SO SENSOR HAS A CLEAR VIEW OF THE ROOM. COORDINATE MOUNTING REQUIREMENTS WITH THE LIGHTING CONTROLS SUPPLIER PRIOR TO ROUGH-

DISPLAY CASE LIGHTS TO SWITCH WITH CORRIDOR LIGHTS.

COORDINATE MOUNTING OF EXIT SIGN WITH THE ARCHITECT PRIOR TO ANY ROUGH-IN. POWER WILL HAVE TO BE ROUTED THROUGH THE DOOR MULLION FROM THE FLOOR AND INTO THE EXIT SIGN.

CONTRACTOR SHALL COORDINATE ALL CONDUIT ROUTING IN THIS SPACE WITH THE ARCHITECT PRIOR TO ANY ROUGH-IN. SEE ARCHITECTS DRAWINGS AND ARCHITECTURAL DETAIL 3C/A541. AT THE COMPLETION OF THE COORDINATION WITH THE ARCHITECT, ALL ROUGH-IN WORK SHALL BE RAN AT RIGHT OR PARALLEL ANGELS AS DISCUSSED AND SHALL BE INSTALLED IN A NEAT WORKMAN LIKE MANNER. IF THE CONTRACTOR FAILS TO COORDINATE WITH THE ARCHITECT, THE CONDUIT WILL BE REROUTED AND REPLACED AT NO ADDITIONAL COST TO THE OWNER. ALL CONDUIT IN THIS SPACE SHALL BE GALVANIZED RIGID CONDUIT (GRC), ALL JUNCTION BOXES FOR THE LIGHT FIXTURES SHALL AS SHALLOW AS POSSIBLE AND SHALL BE RATED FOR 50 LBS MINIMUM. BOX SHALL BE SIZED TO ACCEPT A 3/4" GRC HUB. IF IT IS FOUND THAT EMT CONDUIT IS USED AND THE INCORRECT JUNCTION BOXES ARE USED, THEY WILL BE REPLACED AT NO ADDITIONAL COST TO THE OWNER. NO EXPOSED CONDUIT OR CABLING WILL BE ALLOWED IN THIS SPACE.

COORDINATE INSTALLATION OF LIGHT LEVEL SENSOR AND OCCUPANCY SENSOR WITH THE ARCHITECT AND LIGHTING CONTROLS SYSTEM INSTALLER PRIOR TO ANY ROUGH-IN. SEE KEYED NOTE #11 FOR CONDUIT REQUIREMENTS.

> LOWERCASE LETTER DESIGNATES SWITCHING OR CIRCUIT ASSIGNMENT.

SHADING INDICATES EGRESS LIGHT FIXTURE. CONNECT TO UNSWITCHED

HOT EMERGENCY LIGHTING CIRCUIT.

ASSIGNMENTS, SUCH AS a/b, INDICATE DUAL LEVEL SWITCHING.

LOCATE POWER PACKS (NORMAL AND EMERGENCY) FOR LIGHTING CONTROLS IN A READILY ACCESSIBLE LOCATION IN THE ELECTRICAL ROOM THAT SERVES THE LIGHTS. LABEL POWER PACKS TO INDICATE BRANCH CIRCUIT, AREA AND LIGHTING SERVED.

PROVIDE OCCUPANCY SENSOR FOR HIGH CEILING APPLICATIONS. CONFIRM CEILING HEIGHTS.

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TYPICAL LIGHT FIXTURE CONVENTION SCALE: NONE

- EXIT SIGNS. CONNECT

TO UNSWITCHED HOT EMERGENCY LIGHTING CIRCUIT.

CIRCUIT DESIGNATION — 14L-4

1. SEE ELC SHEETS FOR LIGHTING CONTROL REQUIREMENTS.

Ogden School **District Board**

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AREA A2 LIGHTING
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Sheet Number

EL201

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LIGHTING GENERAL NOTES:

REFER TO ELC SHEETS FOR TYPICAL CONTROL WIRING DIAGRAMS. PROVIDE COMPLETE SYSTEM WITH ALL REQUIRED CONDUIT, WIRING, SWITCHES, SENSORS, POWER PACK, ETC.
 LOCATE POWER PACKS AND ROOM CONTROLLERS ABOVE ACCESSIBLE CEILING NEAR ROOM

3. CONFIRM ALL LOCATIONS OF LIGHT FIXTURES WITH ARCHITECT PRIOR TO INSTALLATION.

KEYED NOTES:


ADJUST LIGHTS IN THIS AREA FOR MECHANICAL EQUIPMENT, PIPING AND DUCTWORK. ADJUST LIGHTING TO ADEQUATELY LIGHT THE ROOM AND SPACES AROUND THE EQUIPMENT.


DAYLIGHT ZONE.



N A Y L O R W E N T W O R T H L U N D A R C H I T E C T S



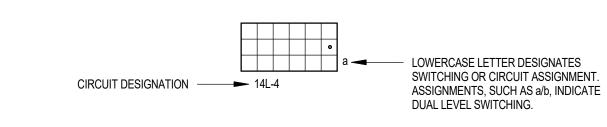

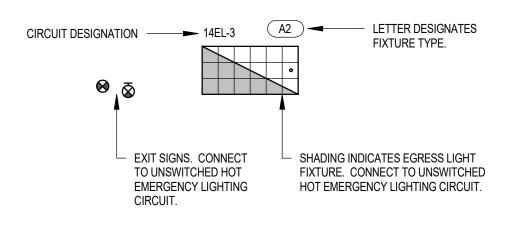

TYPICAL LIGHT FIXTURE CONVENTION
SCALE: NONE

NOTE:

 SEE ELC SHEETS FOR LIGHTING CONTROL REQUIREMENTS. Ogden School District 1950 Monroe Blvd. Ogden, Utah 84401



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Sheet Title
AREA B2 LIGHTING

PLAN
Sheet Number

EL202

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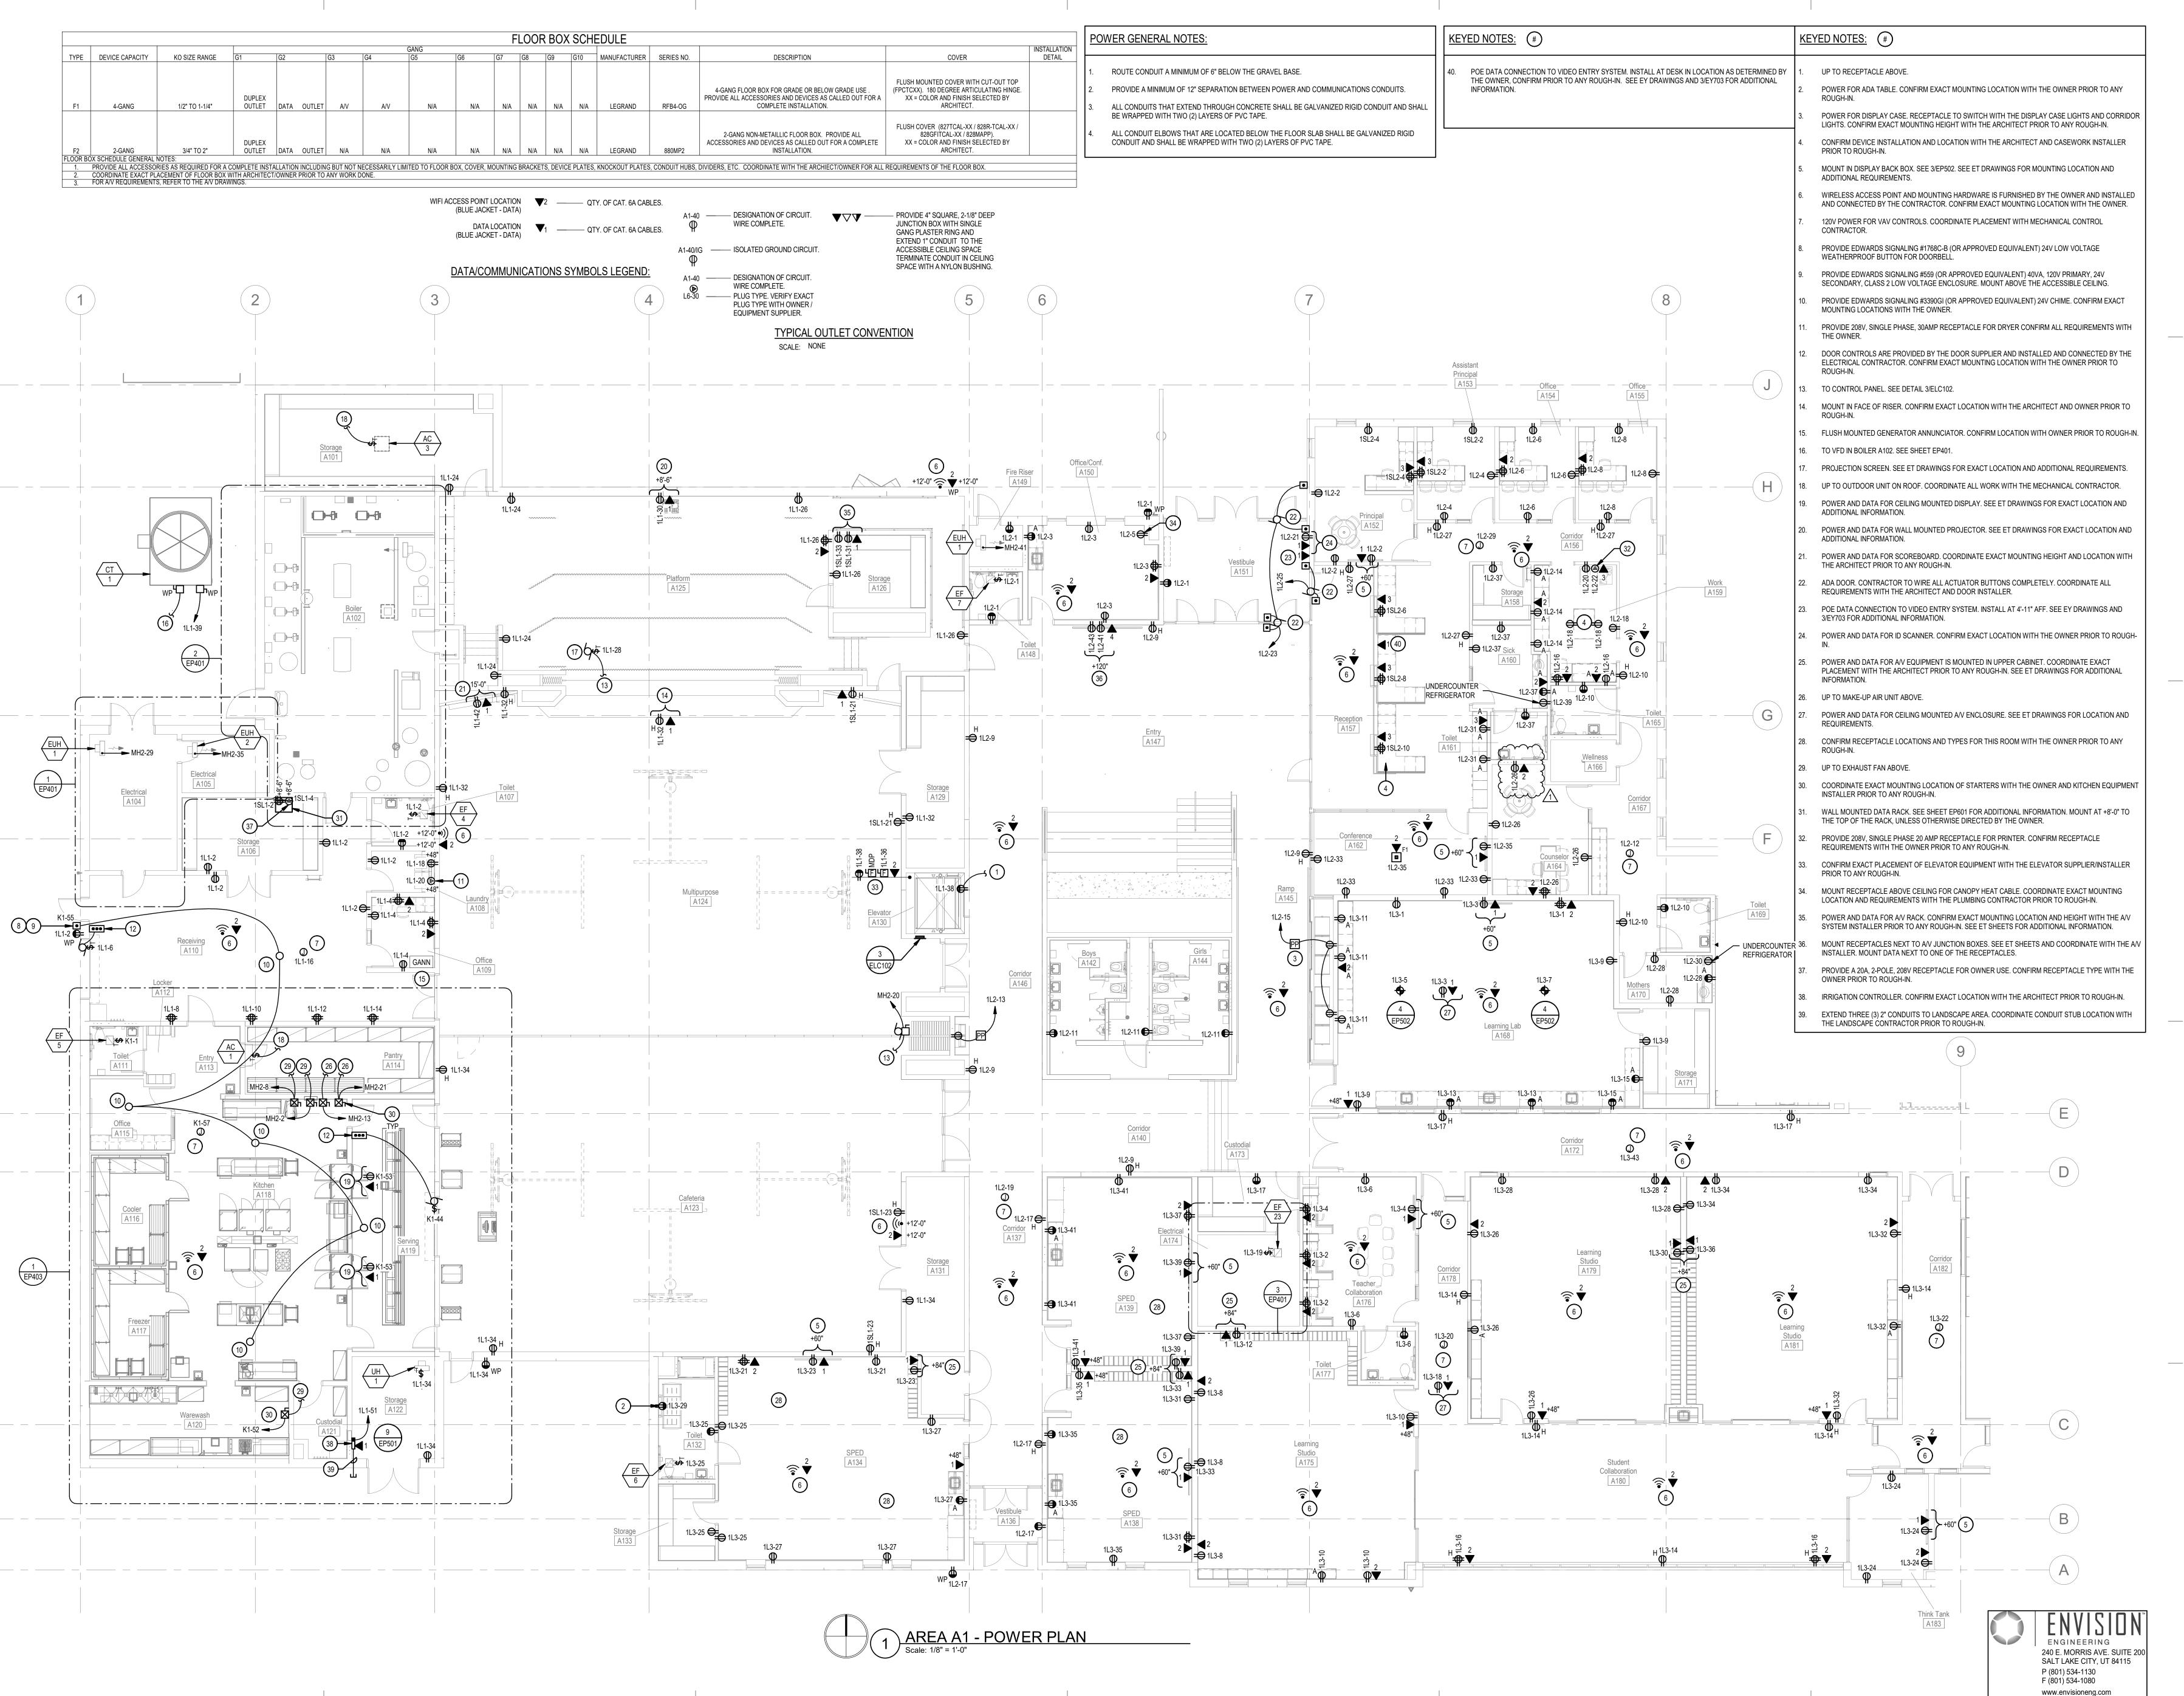
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AREA A1 -POWER PLAN

EP101

TYPICAL OUTLET CONVENTION
SCALE: NONE

EQUIPMENT SUPPLIER.

POWER GENERAL NOTES:

1. ROUTE CONDUIT A MINIMUM OF 6" BELOW THE GRAVEL BASE.

BE WRAPPED WITH TWO (2) LAYERS OF PVC TAPE.

- PROVIDE A MINIMUM OF 12" SEPARATION BETWEEN POWER AND COMMUNICATIONS CONDUITS.
 ALL CONDUITS THAT EXTEND THROUGH CONCRETE SHALL BE GALVANIZED RIGID CONDUIT AND SHALL
- 4. ALL CONDUIT ELBOWS THAT ARE LOCATED BELOW THE FLOOR SLAB SHALL BE GALVANIZED RIGID CONDUIT AND SHALL BE WRAPPED WITH TWO (2) LAYERS OF PVC TAPE.

KEYED NOTES:

- MOUNT IN DISPLAY BACK BOX. SEE 3/EP502. SEE ET DRAWINGS FOR MOUNTING LOCATION AND ADDITIONAL REQUIREMENTS.
- WIRELESS ACCESS POINT AND MOUNTING HARDWARE IS FURNISHED BY THE OWNER AND INSTALLED AND CONNECTED BY THE CONTRACTOR. CONFIRM EXACT MOUNTING LOCATION WITH THE OWNER.

 120V POWER FOR VAV CONTROLS. COORDINATE PLACEMENT WITH MECHANICAL CONTROL
- CONTRACTOR.


 POWER AND DATA FOR AV EQUIPMENT IS MOUNTED IN UPPER CABINET. COORDINATE EXACT
 PLACEMENT WITH THE APPOINTED TO ANY POLICE IN SEE ET PRAWINGS FOR APPITIONAL
- PLACEMENT WITH THE ARCHITECT PRIOR TO ANY ROUGH-IN. SEE ET DRAWINGS FOR ADDITIONAL INFORMATION.

 POWER AND DATA FOR CEILING MOUNTED A/V ENCLOSURE. SEE ET DRAWINGS FOR LOCATION AND
- REQUIREMENTS.

 EXHAUST FAN EF-22 CONTROLS BY MECHANICAL. PROVIDE ALL REQUIRED CONNECTIONS AND NECESSARY ROUGH-IN. COORDINATE ALL WORK WITH THE MECHANICAL CONTRACTOR PRIOR TO ANY
- ROUGH-IN.

 DO NOT LOCATE DATA AND POWER BEHIND DOOR. IF IT IS LOCATED BEHIND THE DOOR, IT WILL BE
- 8. COORDINATE EXACT LOCATION WITH THE ARCHITECT AND MECHANICAL CONTRACTOR PRIOR TO ANY

RELOCATED AT NO ADDITIONAL COST TO THE OWNER.

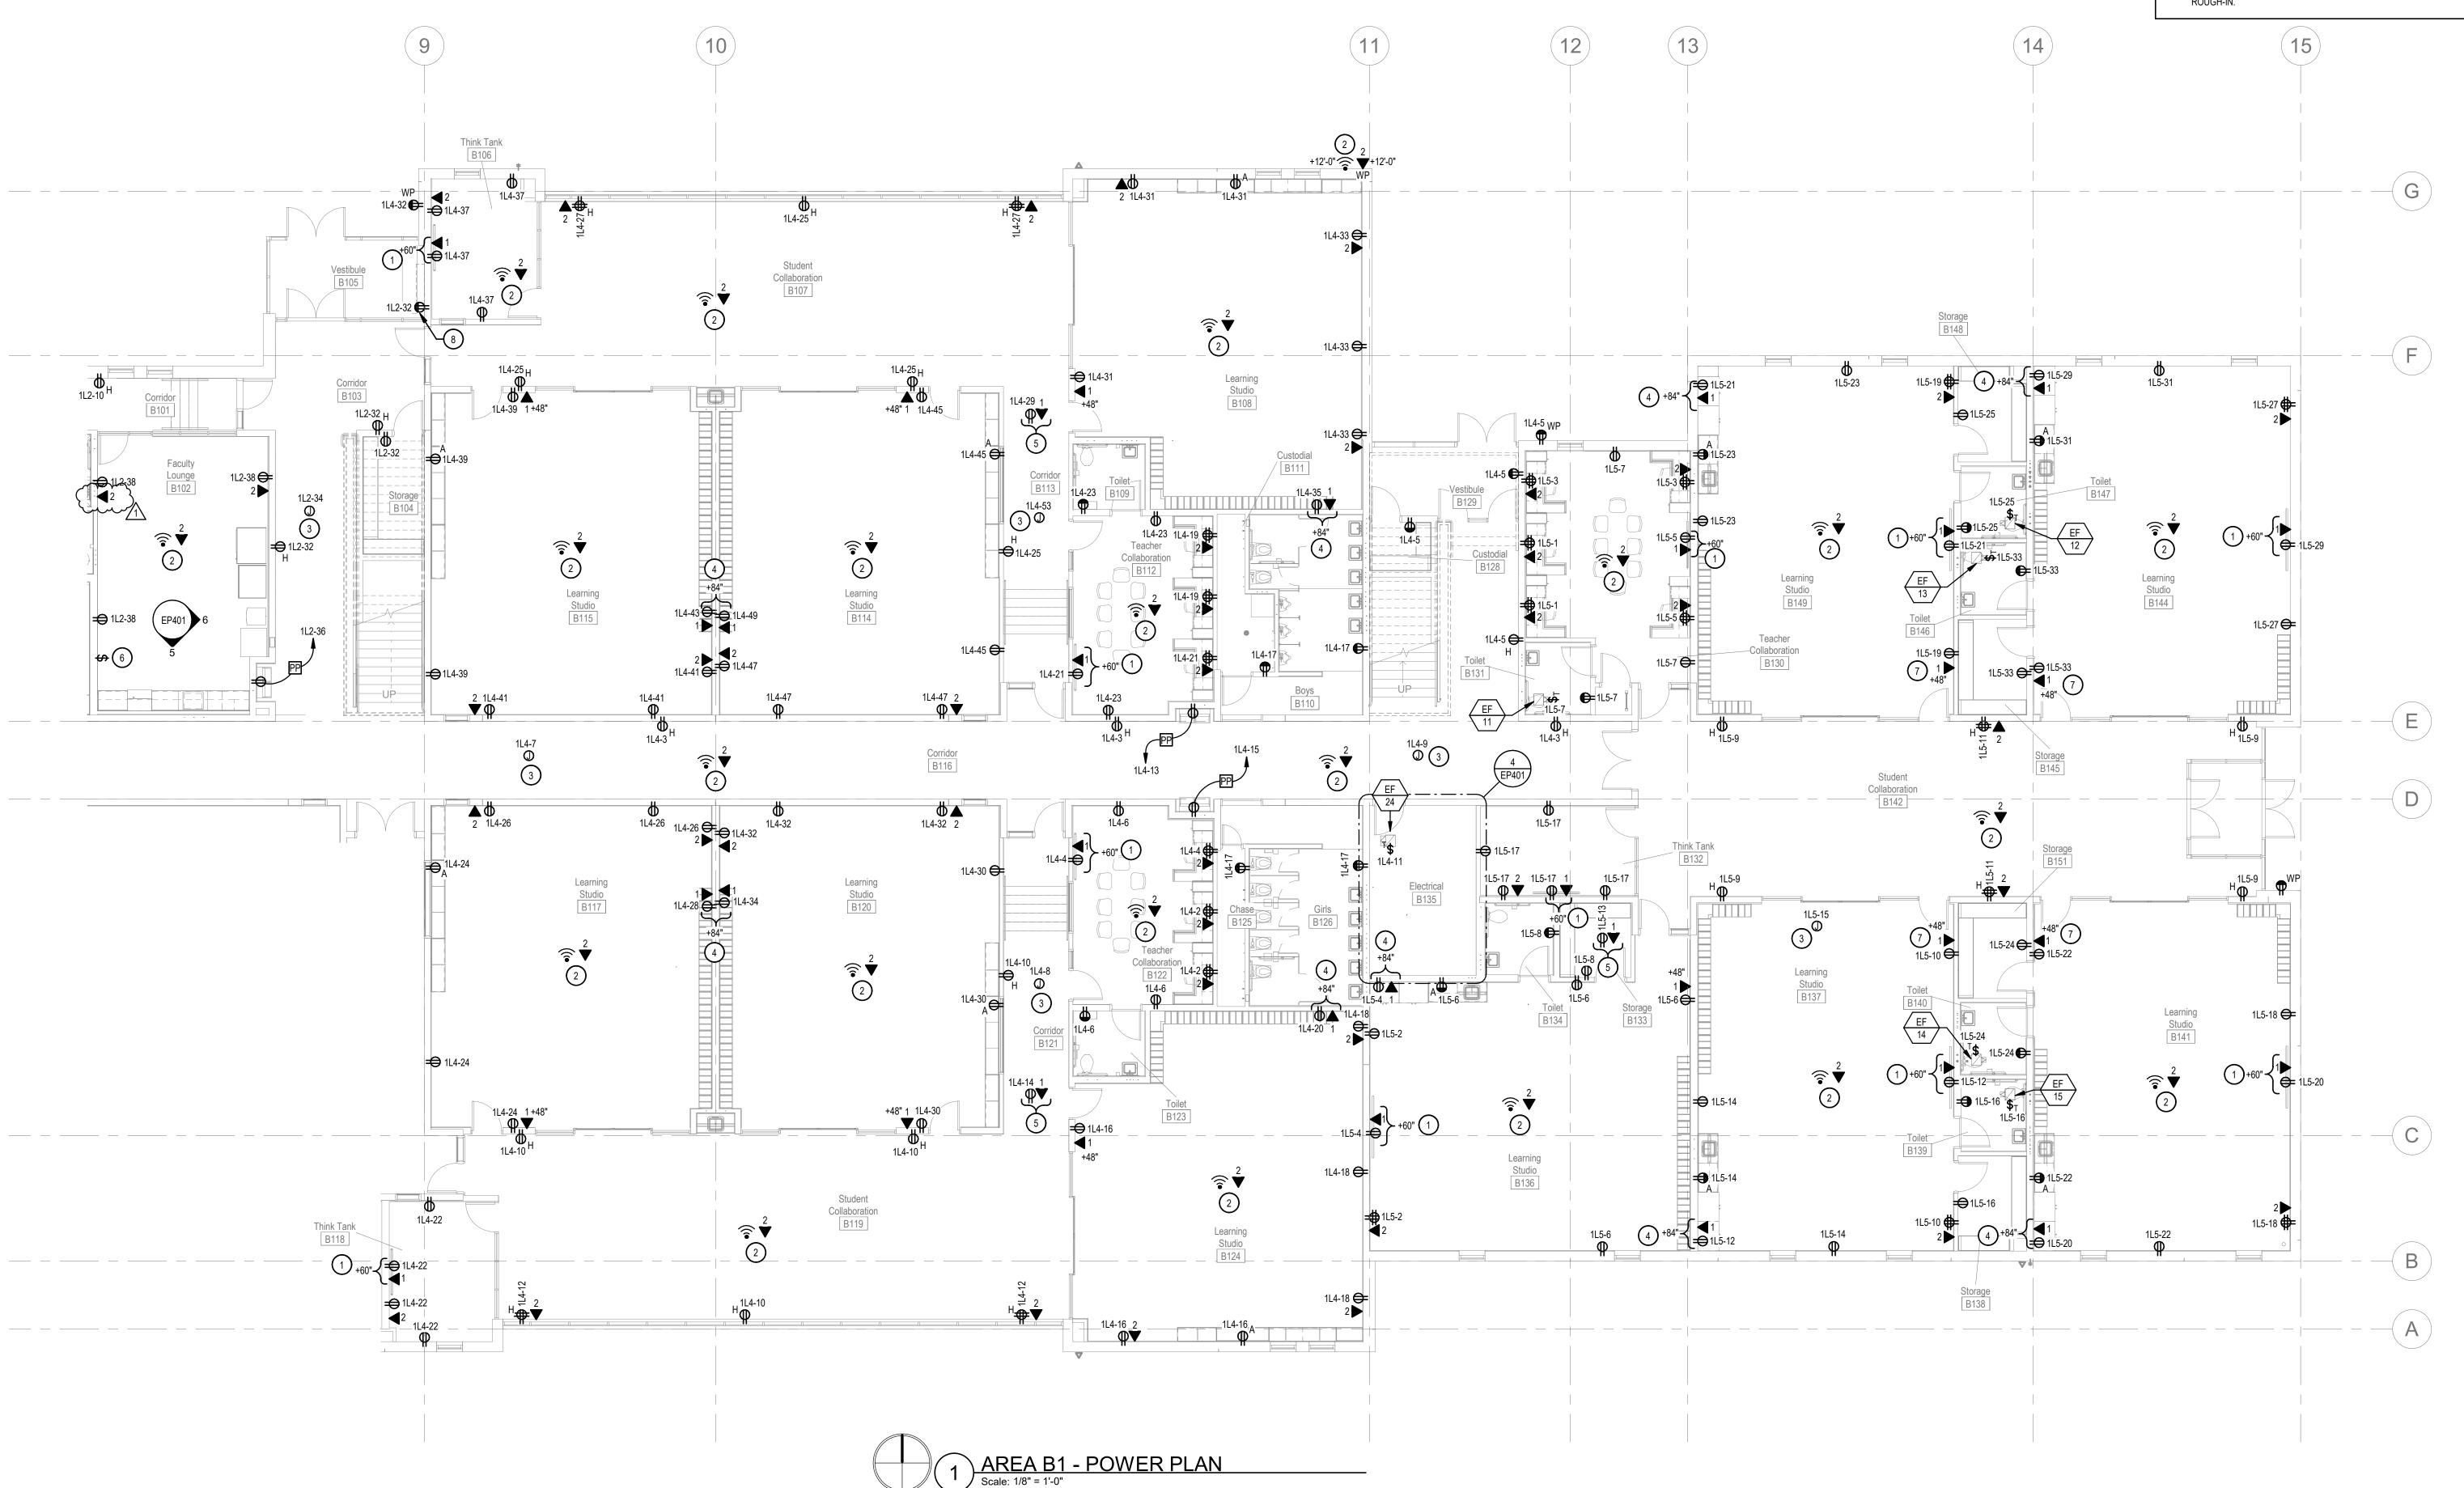

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Stamp

PROFESSIONAL

JEFFREY R.

OWEN

No.177411

OF UTA

07/30/2020

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Ogden School District 1950 Monroe Blvd. Ogden, Utah 84401



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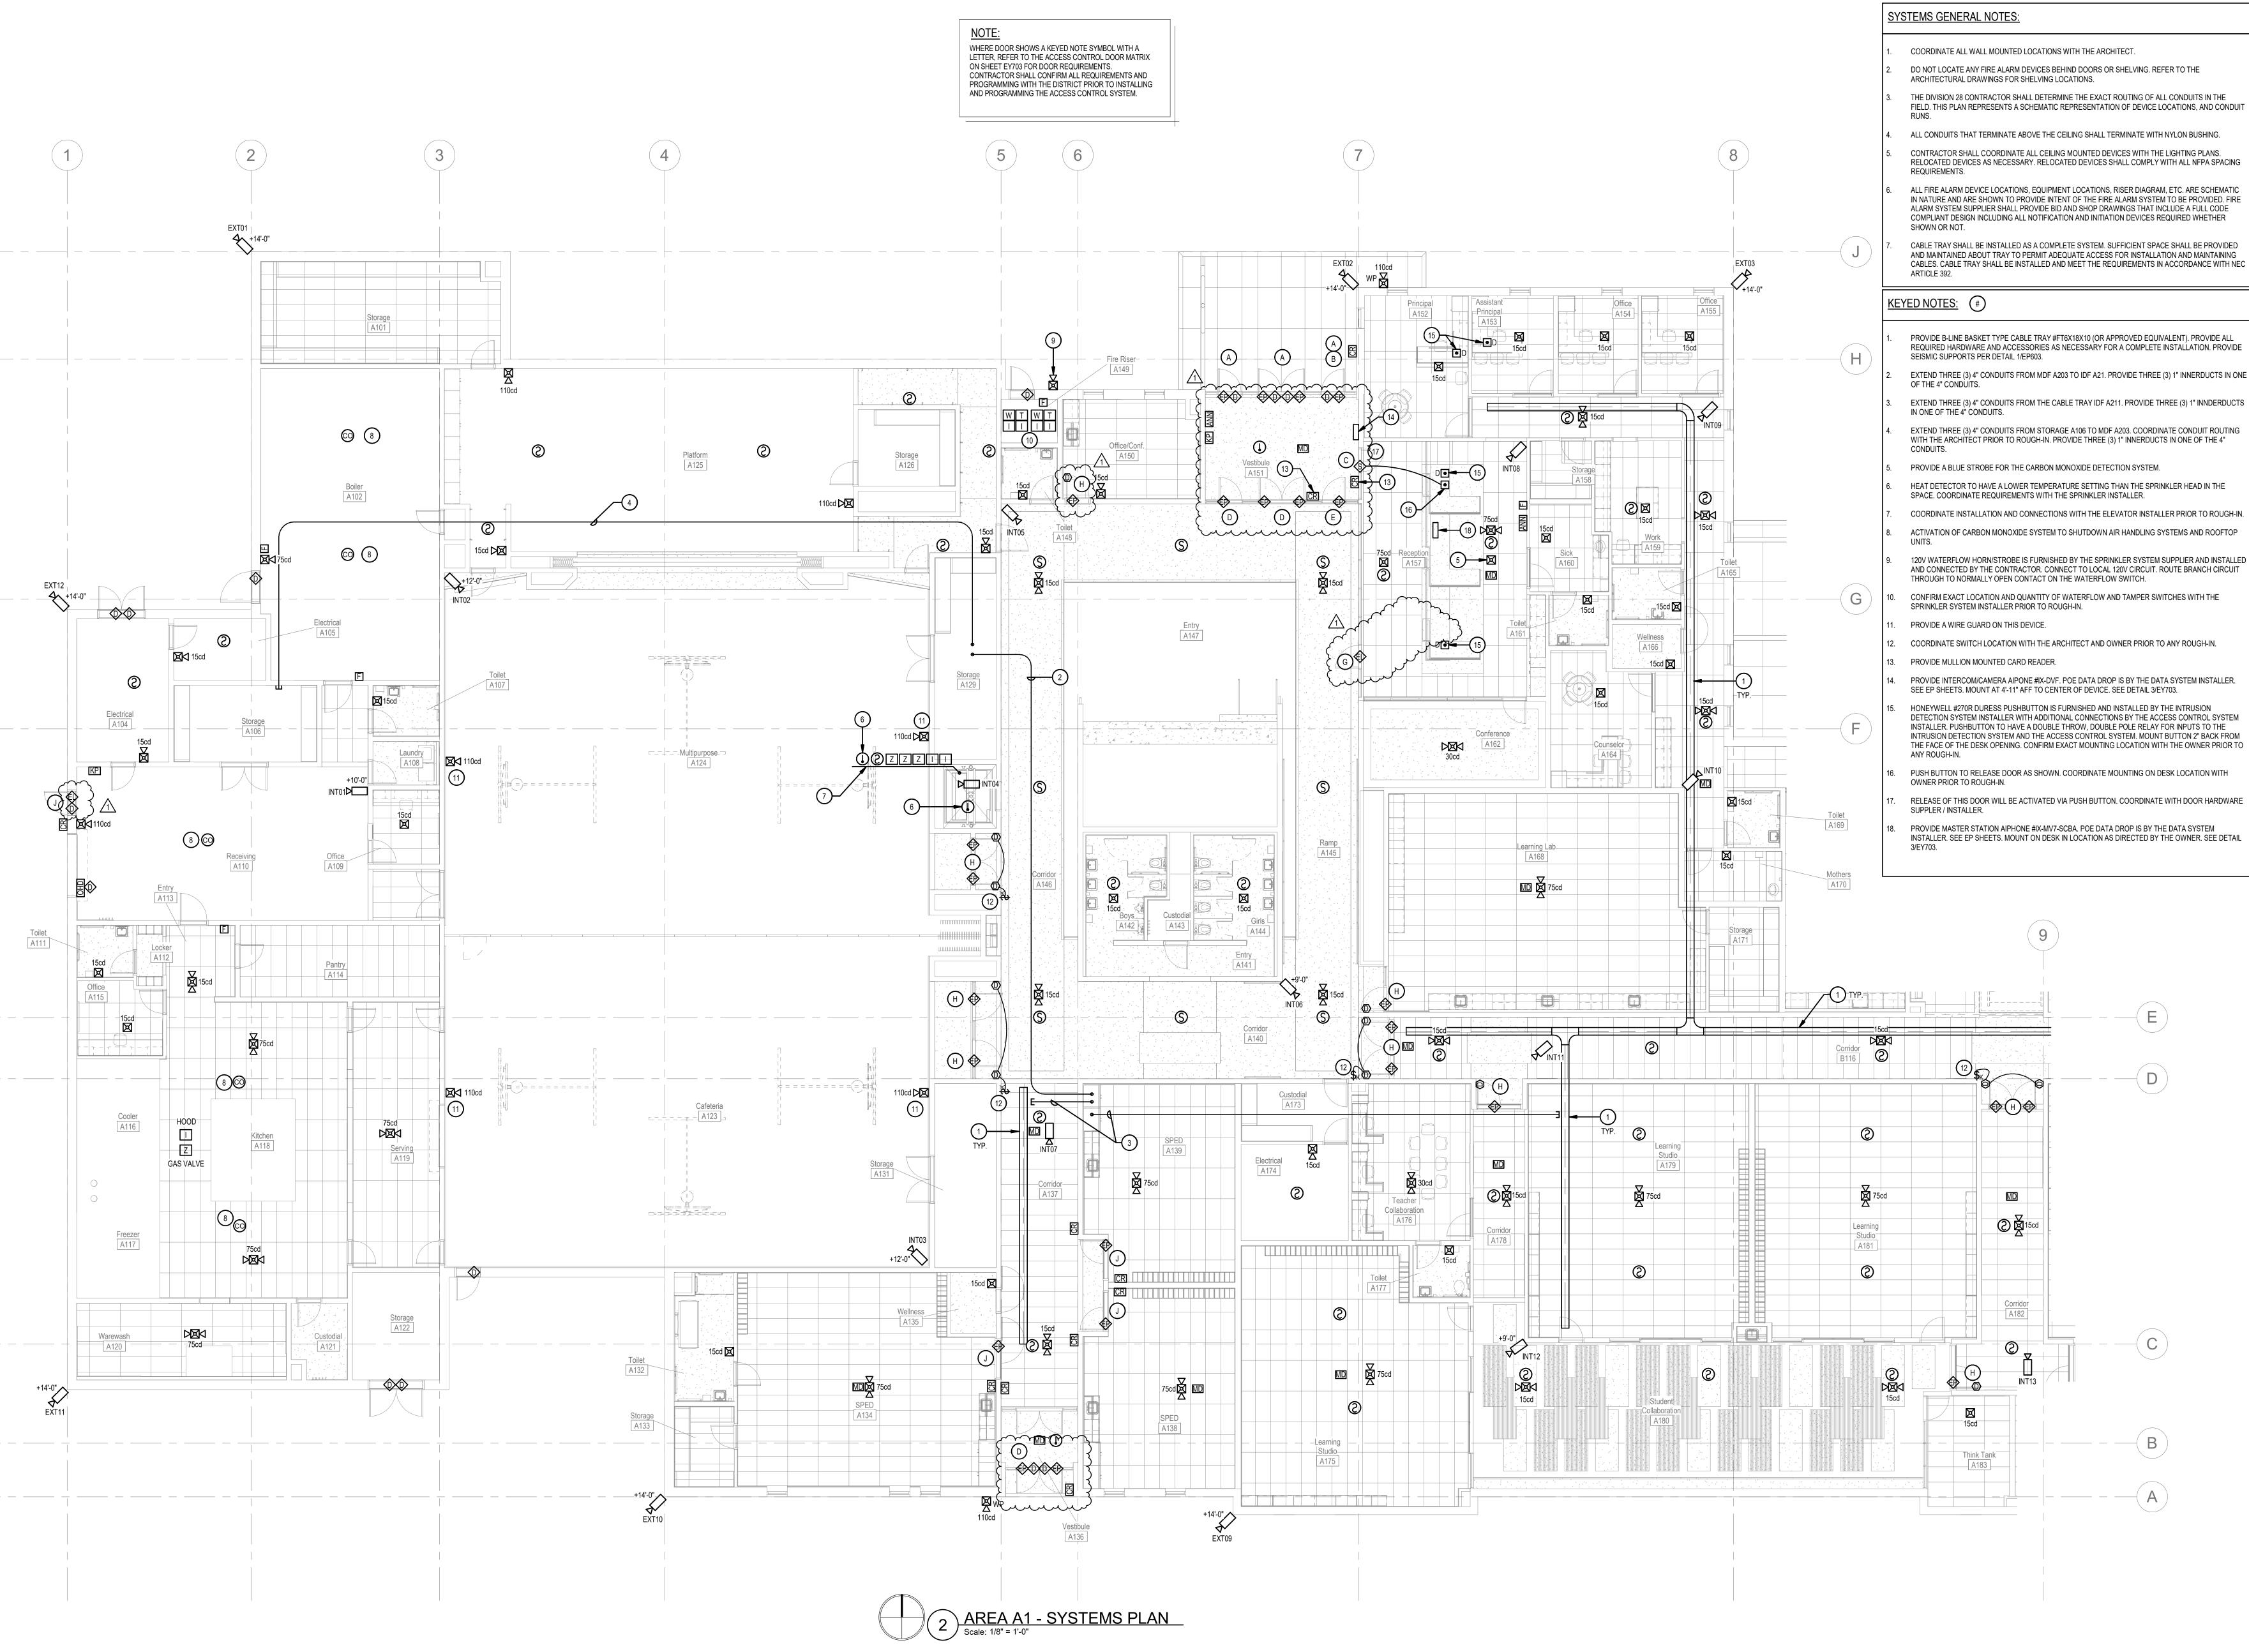
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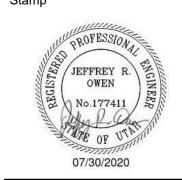
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Sheet Title
AREA B1 POWER PLAN

Sheet Number

EP102





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WHERE DOOR SHOWS A KEYED NOTE SYMBOL WITH A LETTER, REFER TO THE ACCESS CONTROL DOOR MATRIX ON SHEET EY703 FOR DOOR REQUIREMENTS. CONTRACTOR SHALL CONFIRM ALL REQUIREMENTS AND PROGRAMMING WITH THE DISTRICT PRIOR TO INSTALLING AND PROGRAMMING THE ACCESS CONTROL SYSTEM.

KEYED NOTES: #

PROVIDE B-LINE BASKET TYPE CABLE TRAY #FT6X18X10 (OR APPROVED EQUIVALENT). PROVIDE ALL REQUIRED HARDWARE AND ACCESSORIES AS NECESSARY FOR A COMPLETE INSTALLATION. PROVIDE SEISMIC SUPPORTS PER DETAIL 1/EP603.

EXTEND THREE (3) 4" CONDUITS FROM THE CABLE TRAY TO IDF B227. PROVIDE THREE (3) 1" INNERDUCTS IN ONE OF THE 4" CONDUITS.

COORDINATE SWITCH LOCATION WITH THE ARCHITECT AND OWNER PRIOR TO ANY ROUGH-IN. PROVIDE MULLION MOUNTED CARD READER.

SYSTEMS GENERAL NOTES:

COORDINATE ALL WALL MOUNTED LOCATIONS WITH THE ARCHITECT.

DO NOT LOCATE ANY FIRE ALARM DEVICES BEHIND DOORS OR SHELVING. REFER TO THE ARCHITECTURAL DRAWINGS FOR SHELVING LOCATIONS.

THE DIVISION 28 CONTRACTOR SHALL DETERMINE THE EXACT ROUTING OF ALL CONDUITS IN THE FIELD. THIS PLAN REPRESENTS A SCHEMATIC REPRESENTATION OF DEVICE LOCATIONS, AND CONDUIT

ALL CONDUITS THAT TERMINATE ABOVE THE CEILING SHALL TERMINATE WITH NYLON BUSHING. CONTRACTOR SHALL COORDINATE ALL CEILING MOUNTED DEVICES WITH THE LIGHTING PLANS. RELOCATED DEVICES AS NECESSARY. RELOCATED DEVICES SHALL COMPLY WITH ALL NFPA SPACING

ALL FIRE ALARM DEVICE LOCATIONS, EQUIPMENT LOCATIONS, RISER DIAGRAM, ETC. ARE SCHEMATIC IN NATURE AND ARE SHOWN TO PROVIDE INTENT OF THE FIRE ALARM SYSTEM TO BE PROVIDED. FIRE ALARM SYSTEM SUPPLIER SHALL PROVIDE BID AND SHOP DRAWINGS THAT INCLUDE A FULL CODE COMPLIANT DESIGN INCLUDING ALL NOTIFICATION AND INITIATION DEVICES REQUIRED WHETHER

CABLE TRAY SHALL BE INSTALLED AS A COMPLETE SYSTEM. SUFFICIENT SPACE SHALL BE PROVIDED AND MAINTAINED ABOUT TRAY TO PERMIT ADEQUATE ACCESS FOR INSTALLATION AND MAINTAINING CABLES. CABLE TRAY SHALL BE INSTALLED AND MEET THE REQUIREMENTS IN ACCORDANCE WITH NEC ARTICLE 392.

WENTWORTH ARCHITECTS

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WHERE DOOR SHOWS A KEYED NOTE SYMBOL WITH A LETTER, REFER TO THE ACCESS CONTROL DOOR MATRIX ON SHEET EY703 FOR DOOR REQUIREMENTS.
CONTRACTOR SHALL CONFIRM ALL REQUIREMENTS AND PROGRAMMING WITH THE DISTRICT PRIOR TO INSTALLING AND PROGRAMMING THE ACCESS CONTROL SYSTEM.

SYSTEMS GENERAL NOTES:

- 1. COORDINATE ALL WALL MOUNTED LOCATIONS WITH THE ARCHITECT.
- DO NOT LOCATE ANY FIRE ALARM DEVICES BEHIND DOORS OR SHELVING. REFER TO THE ARCHITECTURAL DRAWINGS FOR SHELVING LOCATIONS.


 THE DIVISION 38 CONTRACTOR SHALL DETERMINE THE EXACT POLITING OF ALL CONDUITS IN THE
- THE DIVISION 28 CONTRACTOR SHALL DETERMINE THE EXACT ROUTING OF ALL CONDUITS IN THE
 FIELD. THIS PLAN REPRESENTS A SCHEMATIC REPRESENTATION OF DEVICE LOCATIONS, AND CONDUIT
- ALL CONDUITS THAT TERMINATE ABOVE THE CEILING SHALL TERMINATE WITH NYLON BUSHING.
 CONTRACTOR SHALL COORDINATE ALL CEILING MOUNTED DEVICES WITH THE LIGHTING PLANS.
 RELOCATED DEVICES AS NECESSARY. RELOCATED DEVICES SHALL COMPLY WITH ALL NFPA SPACING REQUIREMENTS.
- 6. ALL FIRE ALARM DEVICE LOCATIONS, EQUIPMENT LOCATIONS, RISER DIAGRAM, ETC. ARE SCHEMATIC IN NATURE AND ARE SHOWN TO PROVIDE INTENT OF THE FIRE ALARM SYSTEM TO BE PROVIDED. FIRE ALARM SYSTEM SUPPLIER SHALL PROVIDE BID AND SHOP DRAWINGS THAT INCLUDE A FULL CODE COMPLIANT DESIGN INCLUDING ALL NOTIFICATION AND INITIATION DEVICES REQUIRED WHETHER SHOWN OR NOT.
- 7. CABLE TRAY SHALL BE INSTALLED AS A COMPLETE SYSTEM. SUFFICIENT SPACE SHALL BE PROVIDED AND MAINTAINED ABOUT TRAY TO PERMIT ADEQUATE ACCESS FOR INSTALLATION AND MAINTAINING CABLES. CABLE TRAY SHALL BE INSTALLED AND MEET THE REQUIREMENTS IN ACCORDANCE WITH NEC ARTICLE 392.

KEYED NOTES:

- 1. PROVIDE B-LINE BASKET TYPE CABLE TRAY #FT6X18X10 (OR APPROVED EQUIVALENT). PROVIDE ALL REQUIRED HARDWARE AND ACCESSORIES AS NECESSARY FOR A COMPLETE INSTALLATION. PROVIDE SEISMIC SUPPORTS PER DETAIL 1/EP603.
- 2. ACTIVATION OF CARBON MONOXIDE SYSTEM TO SHUTDOWN AIR HANDLING SYSTEMS AND ROOFTOP
- 3. COORDINATE INSTALLATION AND SHUTDOWN CONNECTIONS WITH THE MECHANICAL CONTRACTOR.
- 4. FLOOR MOUNTED DOOR HOLDER. COORDINATE INSTALLATION WITH THE ARCHITECT AND DOOR HARDWARE SUPPLIER PRIOR TO ANY ROUGH-IN.





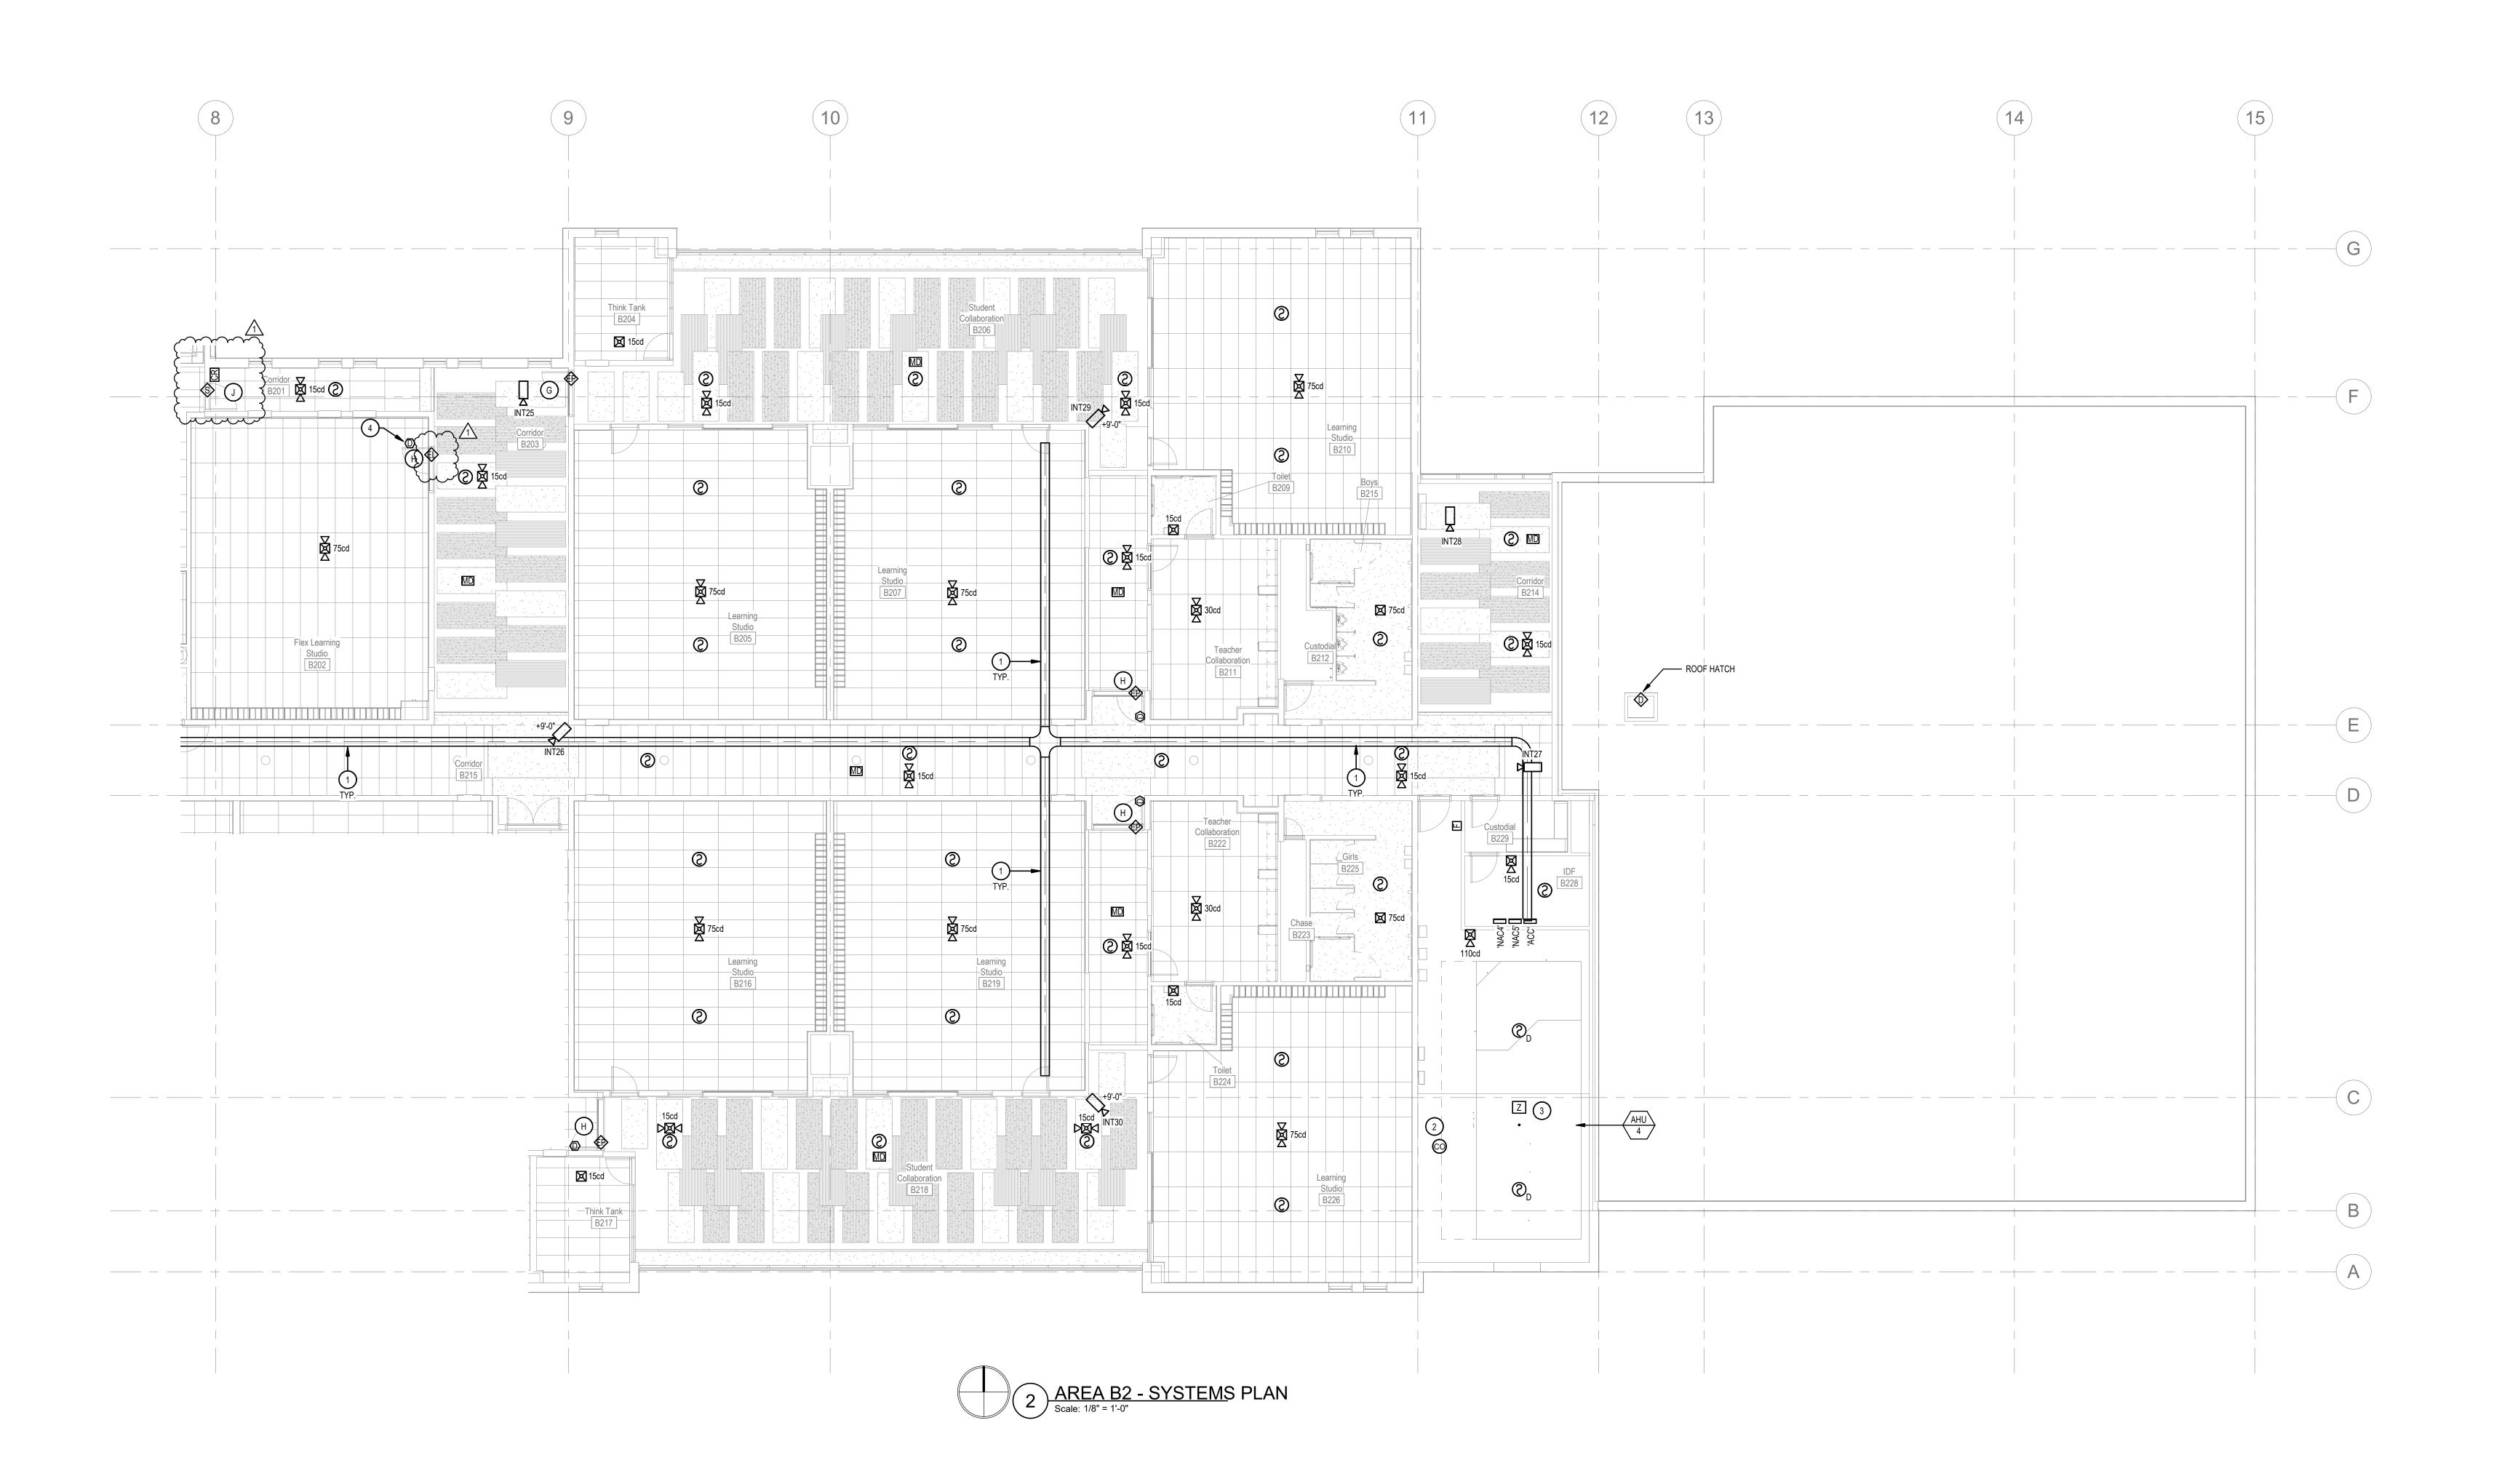

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Project Number 143.004


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Sheet Title
AREA B2 -

Sheet Title
AREA B2 SYSTEMS
PLAN
Sheet Number

EY202

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ACCESS CONTROL SYSTEM RISER DIAGRAM

PROVIDE QUANTITY OF POWER SUPPLIES AS NECESSARY TO POWER DOOR HARDWARE AS SHOWN

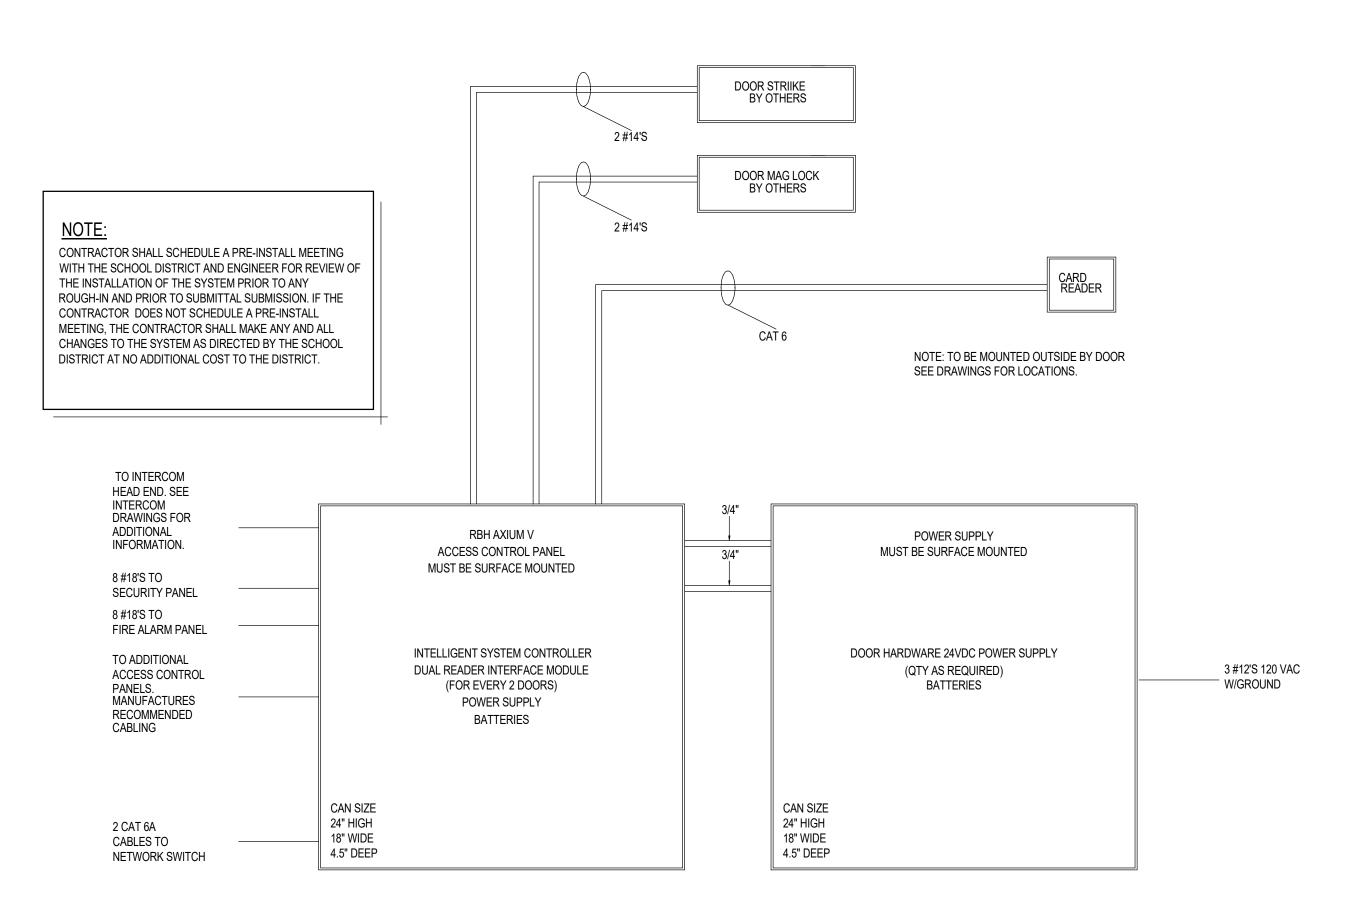MOUNT BUTTON BELOW RECEPTION COUNTER IN A LOCATION AS DIRECTED BY THE OGDEN SCHOOL DISTRICT.

AIPHONE #IX-DVF - DOOR STATION IN VESTIBULE

4'-11" AFF TO

CENTER OF DEVICE

ACCESS CONTROL SYSTEM EQUIPMENT LIST

PROVIDE CARD READERS TO SUIT APPLICATION

REFER TO ARCHITECTURAL DOOR HARDWARE SPECIFICATIONS

REFER TO ARCHITECTURAL DOOR HARDWARE SPECIFICATIONS

REFER TO ARCHITECTURAL DOOR HARDWARE SPECIFICATIONS

DESCRIPTION

RBH AXIUM V HEAD END CONTROLLER

ALTRONIX - AX-AL600ULM

PROXIMITY CARD READERS:

WALL-MOUNTED - HID 5355

MULLION MOUNT - HID 5365

ELECTRIC PANIC HARDWARE

MAGNETIC DOOR CONTACT SWITCH

AIPHONE #IX-MV7-SCBA - MASTER STATION

0

MOUNT AT RECEPTION DESK IN LOCATION

AS DIRECTED BY THE OWNER

(1) CAT 6A TO POE SWITCH.

SEE POWER PLANS

ELECTRIC DOOR STRIKE

ELECTRIC STRIKE RELEASE

MAIN ACCESS CONTROL SYSTEM PANEL:

- 1. PROVIDE ACCESS CONTROL SYSTEM. REFER TO THE SPECIFICATIONS FOR ADDITIONAL INFORMATION .
- CONFIRM ALL WIRING REQUIREMENTS WITH ACCESS CONTROL SYSTEM SUPPLIER AND PROVIDE IN ACCORDANCE THEREWITH.
- 3. THE SYSTEM SHALL BE PROGRAMMED PER ALL OWNERS REQUIREMENTS. VERIFY PRIOR TO ANY PROGRAMMING.
- WIRING SHALL BE CONTINUOUS FROM ONE DEVICE TO ANOTHER. NO SPLICING IS ALLOWED.
- 5. PROVIDE ACCESS CONTROL MAP OF THE BUILDING SHOWING ALL ACCESS CONTROL SYSTEM DEVICES. LOCATE MAP IN LOCATION AS DIRECTED BY THE OWNER.
- 6. ALL ACCESS CONTROL CABLING SHALL BE RUN IN CONDUIT. MINIMUM CONDUIT SIZE SHALL BE 3/4". ALL JUNCTION BOXES SHALL BE PAINTED AND LABELED PER ALL OWNER REQUIREMENTS.
- 7. VERIFY ALL LOCATIONS OF ACCESS CONTROL DEVICES WITH THE OWNER PRIOR TO ANY ROUGH-IN.
- 8. THE ACCESS CONTROL SYSTEM SUPPLIER SHALL PROVIDE COMPUTER DRAFTED SHOP DRAWINGS OF THE ENTIRE ACCESS CONTROL SYSTEM USING FLOOR PLANS PROVIDED BY THE ENGINEER. SHOP DRAWINGS TO INCLUDE PLANS, SECTIONS, ELEVATIONS, FINAL DEVICE LOCATIONS, CONDUIT SIZE AND ROUTING AND ALL CONDUCTOR SIZES. TYPICAL RISERS AND COPYING AND SUBMITTING THE CONTRACT DOCUMENTS

CONTROL DOOR SEQUENCE OF OPERATIONS

EXTERIOR ACCESS CONTROLLED DOORS SHALL FUNCTION AS FOLLOWS:

1. THE EXTERIOR ACCESS CONTROLLED DOORS SHALL FUNCTION AS DIRECTED BY THE OWNER FOR LOCKING AND UNLOCKING DURING NORMAL

WILL NOT BE ACCEPTED.

- 2. THE EXTERIOR ACCESS CONTROLLED DOORS SHALL GO INTO LOCK DOWN MODE AND LOCK ALL EXTERIOR DOORS ONCE THE LOCK DOWN BUTTON IS PUSHED IN THE PRINCIPAL OFFICE. PUSHING THE LOCK DOWN BUTTON AGAIN WILL RETURN ALL THE EXTERIOR DOORS THE STATE OF FUNCTION PRIOR TO THE LOCK DOWN BUTTON BEING PUSHED.
- 3. ONCE THE LOCK DOWN BUTTON IN THE PRINCIPAL'S OFFICE IS PUSHED AND THE ACCESS CONTROLLED DOORS ARE IN LOCK DOWN MODE, THE SECURITY SYSTEM SHALL CALL THE MONITORING COMPANY AND NOTIFY THE MONITORING COMPANY THAT THE SCHOOL IS IN LOCK DOWN AND DISPATCH AS PREDETERMINED BY THE OWNER.

INTERIOR ACCESS CONTROLLED DOORS FOR THE WINGS SHALL FUNCTION AS FOLLOWS:

- 1. PRESENTING A CARD TO THE CARD READER AT THE DOOR WILL RELEASE THE MAGNETIC DOOR HOLDERS AND ENERGIZE THE ELECTRIC DOOR STRIKES TO LOCK THE DOORS. PRESENTING A CARD A SECOND TIME WILL DE-ENERGIZE THE ELECTRIC DOOR STRIKES AND ENERGIZE THE MAGNETIC DOOR HOLDERS TO HOLD THE DOORS IN THE OPEN POSITION. DOOR WILL HAVE TO BE PHYSICALLY OPENED SO THE MAGNETIC DOOR HOLDERS WILL HOLD THEM OPEN.
- 2. THE NEW INTERIOR ACCESS CONTROLLED DOORS SHALL GO INTO LOCK DOWN MODE (RELEASE MAGNETIC DOOR HOLDERS AND ENERGIZE ELECTRONIC STRIKES) AND LOCK ALL NEW INTERIOR DOORS ONCE THE LOCK DOWN BUTTON IS PUSHED IN THE MAIN OFFICE. PUSHING THE LOCK DOWN BUTTON AGAIN WILL RETURN ALL THE NEW INTERIOR DOORS TO THE STATE OF FUNCTION PRIOR TO THE LOCK DOWN BUTTON BEING PUSHED. NEW INTERIOR DOORS WILL HAVE TO BE PHYSICALLY REOPENED SO THE MAGNETIC DOOR HOLDERS WILL HOLD THEM OPEN.

DOOR ROUGH-IN GENERAL NOTES:

- 1. CONTRACTOR SHALL WORK CLOSELY WITH THE DOOR HARDWARE SUPPLIER AND ACCESS CONTROL SYSTEM SUPPLIER FOR DOOR
- REQUIREMENTS, ROUGH-IN AND WIRING.
 2. CONTRACTOR SHALL COORDINATE ALL JUNCTION BOX ROUGH-IN LOCATIONS WITH THE OWNER AND ACCESS SYSTEM CONTROL SYSTEM
- SUPPLIER PRIOR TO ANY ROUGH-IN.

 3. ALL CABLING TO DEVICES THAT ARE INSTALLED WITHIN DOOR OR ON MULLIONS SHALL BE ROUTED THROUGH THE MULLIONS. COORDINATE INSTALLATION WITH THE WINDOW SYSTEM INSTALLER PRIOR TO ANY ROUGH-IN.

								ACCE	SS CONT	ROL DO	OR MATRIX
L DOOR			HONE SY	_		ACCE	SS CONTRO CARD	L SYSTEM LOCK-DOWN	ADA	INTERCOM	SEQUENCE OF OPERATION
DESIGNATION	1	2	3	4	5	PROGRAM	READER	PUSH BUTTON	CONTROLLER	CAMERA	
A						X		X			PROGRAMMED TO BE UNSECURE DURING SCHOOL HOURS AND SECURE AFTER HOURS SECURE UPON LOCK-DOWN INITIATION
В						X	X	X	X		PROGRAMMED TO BE UNSECURE DURING SCHOOL HOURS AND SECURE AFTER HOURS SECURE UPON LOCK-DOWN INITIATION ADA DOOR CONTROLLER TO BE DISABLED IF DOOR IS SECURE AND ENABLED IF UNSECURE SECURE DISABLED UPON CARD READER ACTIVATION
С						X	X			X	PROGRAMMED TO BE NORMALLY SECURE SECURE DISABLED BY OFFICE STAFF UPON VERIFICATION VIA INTERCOM SYSTEM ADA DOOR CONTROLLER TO BE DISABLED IF DOOR IS SECURE AND ENABLED IF UNSECURE SECURE DISABLED UPON CARD READER ACTIVATION
D						х		Х			PROGRAMMED TO BE UNSECURE FOR A PERIOD PRIOR TO SCHOOL OPENING TO ALLOW STUDENT ACCES AND SECURE DURING SCHOOL HOURS SECURE UPON LOCK-DOWN INITIATION SECURE DISABLED UPON CARD READER ACTIVATION
E						X	Х	Х	Х		PROGRAMMED TO BE UNSECURE FOR A PERIOD PRIOR TO SCHOOL OPENING TO ALLOW STUDENT ACCES AND SECURE DURING SCHOOL HOURS SECURE UPON LOCK-DOWN INITIATION ADA DOOR CONTROLLER TO BE DISABLED IF DOOR IS SECURE AND ENABLED IF UNSECURE SECURE DISABLED UPON CARD READER ACTIVATION
F						Х	Х	Х			PROGRAMMED TO BE NORMALLY UNSECURE SECURE UPON LOCK-DOWN INITIATION SECURE DISABLED UPON CARD READER ACTIVATION DURING LOCK-DOWN ONLY
G						Х		Х			PROGRAMMED TO BE NORMALLY UNSECURE SECURE UPON LOCK-DOWN INITIATION
Н						Х		Х			PROGRAMMED TO BE NORMALLY UNSECURE HELD OPEN BY MAGNETIC DOOR HOLDERS (CONTROLLED FROM FIRE ALARM PANEL) RELEASE UPON KEYED SWITCH OR LOCK-DOWN INITIATION
J						Х	Х				PROGRAMMED TO BE NORMALLY SECURE SECURE DISABLED UPON CARD READER ACTIVATION

DOORS HELD OPEN BY MAGNETIC DOOR HOLDERS:

DOORS THAT ARE HELD OPEN BY MAGNETIC DOOR HOLDER SHALL FUNCTION AS FOLLOWS:

FIRE ALARM

UPON ACTIVATION OF THE FIRE ALARM SYSTEM THE DOORS BEING HELD OPEN WITH MAGNETIC DOOR HOLDERS SHALL RELEASE AND CLOSE.

THE FIRE ALARM SYSTEM SHALL NOTIFY THE ACCESS CONTROL SYSTEM THAT THE FIRE ALARM HAS ACTIVATED AND UNLOCK ALL DOORS THAT ARE CONTROLLED THROUGH THE ACCESS CONTROL SYSTEM.

UPON ACTIVATION OF A LOCK DOWN THE ACCESS CONTROL PANEL SHALL LOCK ALL DOORS CONTROLLED BY THE ACCESS CONTROL SYSTEM.

THE ACCESS CONTROL SYSTEM SHALL NOTIFY THE FIRE ALARM SYSTEM
THAT A LOCK DOWN HAS BEEN INITIATED AND RELEASE ALL DOOR HELD

OPEN WITH MAGNETIC DOOR HOLDERS.

THE FIRE ALARM SYSTEM AND ACCESS CONTROL SYSTEM INTEGRATORS SHALL WORK CLOSELY TOGETHER AND WITH THE DISTRICT TO PROVIDE THE REQUIRED PROGRAMMING AND INPUTS SO DOORS FUNCTION AS STATED

CONTRACTOR SHALL SCHEDULE A PRE-INSTALL MEETING WITH THE SCHOOL DISTRICT AND ENGINEER FOR REVIEW OF

ROUGH-IN AND PRIOR TO SUBMITTAL SUBMISSION. IF THE

THE INSTALLATION OF THE SYSTEM PRIOR TO ANY

CONTRACTOR DOES NOT SCHEDULE A PRE-INSTALL

DISTRICT AT NO ADDITIONAL COST TO THE DISTRICT.

MEETING, THE CONTRACTOR SHALL MAKE ANY AND ALL

CHANGES TO THE SYSTEM AS DIRECTED BY THE SCHOOL

KEYPAD (TYP.) KP

4 CONDUCTOR #22 AWG PLENUM RATED CABLE WITH BLACK JACKET

TO MAIN DATA RACK DIA

(2) 4 TWISTED PAIR #24 AWG CATEGORY 6
BLUE JACKET

TO MAIN DATA RACK WE

4 TWISTED PAIR #24 AWG CATEGORY 6
BLUE JACKET

120V STANDBY POWER

2 INTRUSION DETECTION SYSTEM RISER DIAGRAM
SCALE: NONE

INTRUSION

DETECTION

INTRUGION RETECTION OVOTEM FOLURNENT LIGT							
	INTRUSIC	ON DETECTI	ON SYSTEM EQUIP	MENI LISI			
L	DESCRIPTION	SUPPLIER	MODEL	REQUIREMENTS			
INT	MAIN INTRUSION DETECTION CONTROL PANEL	DSC	MAXSYS PC4020 NK	EXPANDABLE UP TO 128 ZONES. PROVIDE ZONE EXPANDER MODULES PC4116 AS MAY BE REQUIRED. EACH ALARM DEVICES REQUIRES A DEDICATED ZONE			
КР	KEY PAD	DSC	LC04501	CONFIRM LOCATION OF ALL KEYPADS WITH OGDEN SCHOOL DISTRICT PRIOR TO ROUGH-IN			
MD	MOTION DETECTOR - PIR, 360 DEGREES, 50' DIAMETER	TAKEX	PA-6810E	CEILING-MOUNTED			
\bigotimes	MAGNETIC DOOR CONTACT SWITCH	-	-	REFER TO ARCHITECTURAL DOOR HARDWARE SPECIFICATIONS			
OHS	OVERHEAD MAGNETIC DOOR CONTACT SWITCH	GE SENTROL	2205A	COORDINATE INSTALLATION WITH OVERHEAD DOOR INSTALLER			
o D	DURESS / LOCK DOWN BUTTON	HONEYWELL	270R	2 POLE, DOUBLE THROW DEVICE. CONFIRM MOUNTING LOCATION PRIOR TO ANY ROUGH-IN			

4 CONDUCTOR #22 AWG PLENUM RATED CABLE WITH BLACK JACKET, VIA 3/4" C OR CABLE TRAY

— 4 CONDUCTOR #22 AWG PLENUM RATED CABLE

(TYPICAL)

MOTION DETECTOR

— 1"C WITH CABLES PER MANUFACTURER'S RECOMMENDATIONS

ACC ACCESS CONTROL PANEL

- 1"C WITH CABLES PER MANUFACTURER'S RECOMMENDATIONS

- 1"C WITH CABLES PER MANUFACTURER'S RECOMMENDATIONS

WITH BLACK JACKET

INTRUSION DETECTION SYSTEM GENERAL NOTES:

- ALLOW SUFFICIENT LENGTH OF CABLE FOR TERMINATION AT EACH END.
- 2. PROVIDE PLENUM RATED CABLE.
- 3. LABEL ALL CABLES AT BOTH ENDS WITH ROOM NUMBER.
- 4. PROVIDE A DEDICATED ZONE FOR EACH DEVICE.
- 5. COORDINATE ALL REQUIREMENTS WITH OGDEN SCHOOL DISTRICT PRIOR TO ROUGH-IN.
- 6. THE SECURITY SYSTEM SUPPLIER SHALL PROVIDE COMPUTER DRAFTED SHOP DRAWINGS OF THE ENTIRE SECURITY SYSTEM USING FLOOR PLANS PROVIDED BY THE ENGINEER. SHOP DRAWINGS TO INCLUDE PLANS, SECTIONS, ELEVATIONS, FINAL DEVICE LOCATIONS, CONDUIT SIZE AND ROUTING AND ALL CONDUCTOR SIZES. TYPICAL RISERS WILL NOT BE ACCEPTED.
- 7. WIRING REQUIREMENTS: ALL SYSTEM WIRING (EXCEPT LINE VOLTAGE AND TELEPHONE CONNECTIONS) SHALL BE MINIMUM 18 AWG STRANDED COPPER. TELEPHONE CONNECTIONS SHALL BE MINIMUM CAT-6 AND CONNECTED TO THE PANEL TELEPHONE LINE CONNECTION TERMINALS VIA RJ31X TELEPHONE JACKS AND CORDS. DIRECT WIRING OF TELEPHONE LINES TO PANEL CIRCUIT BOARD IS NOT ACCEPTABLE.
- 8. WIRE COLOR CODE:
- A DOOR CONTACTS: YELLOW, GREEN
 B MOTION DETECTORS: RED, BLACK, YELLOW, GREEN
- C COM-BUS CIRCUIT: RED, BLACK, YELLOW, GREEN
 D AUDIBLE DEVICES: RED, BLACK.
- E WIRE COLOR FOR ANY CIRCUIT NOT LISTED SHALL BE APPROVED BY OGDEN SCHOOL DISTRICT PRIOR TO INSTALLATION.
- 9. ROUGH-IN: PROVIDE AN 8"L X 8"W X 8" D GUTTER LOCATED ABOVE ENCLOSURE LOCATION. THE GUTTER SHALL BE BLANK (NO KNOCKOUTS) AND BE MOUNTED AT 76" AFF TO THE BOTTOM EDGE OF THE GUTTER. THE SYSTEM ENCLOSURE SHALL BE SURFACE MOUNTED AT 72" AFF TO THE TOP OF THE ENCLOSURE, AND INSTALLED ONLY AFTER ALL WALL BOARD AND PAINTING WORK IS COMPLETE. MOUNTING ENCLOSURES OR GUTTERS WITH POWDER ACTUATED ANCHORING SYSTEM IN NOT ACCEPTABLE. ALL WIRING SHALL ENTER SYSTEM ENCLOSURE THROUGH MINIMUM 1-1/4" NIPPLES LOCATED ON THE TOP FAR RIGHT HAND SIDED OF THE ENCLOSURE. PROVIDE PLASTIC BUSHINGS ON ALL NIPPLES.
- FOR LONG RUNS OF POWER WIRING, INCREASE WIRE SIZE PER MANUFACTURERS REQUIREMENTS.
- 11. PROVIDE ALL NECESSARY RELAY CONTACTS IN INTRUSION DETECTION SYSTEM MAIN PANEL FOR INTEGRATION TO FACP FOR MONITORING OF DURESS PUSHBUTTON AND SUBSEQUENT RELEASE OF ALL DOORS HELD OPEN BY MAGNETIC DOOR HOLDERS IN A LOCK DOWN EVENT.
- 12. PROVIDE A DEDICATED ZONE FOR EACH DEVICE; THE ONLY ALLOWABLE EXCEPTION IS WHEN
 (2) TWO DEVICES MONITOR A COMMON DOOR.

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OT/30/2020

N A V I A R

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Project For
The
Ogden School
District Board
of Education

T.O. Smith Elementary School Rebuild

3295 Gramercy Ave

Ogden, Utah 84403

Project Phase
Bid Documents

Revision Schedule

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INTRUSION
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CONTOL

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